October 4, 2024

PROJECT NAME: DIMOVSKI DUPLEXES 2024

PROJECT NUMBER: 2024070025

APPLICATION: MINOR SITE PLAN #31762

1 DEPARTMENT: ENRAA - ACQ AGENT ENG ROW

REVIEW ITEM: Minor Site Plan STATUS OF REVIEW: INFO REMARKS: IF APPLICABLE:

Sec. 2.18.2.I Show connections to other phases.

Sec. 2.19.2.H. Legal documents such as Declaration of Covenants and Restrictions, By-Laws, Articles of Incorporation, ordinances, resolutions, etc.

Required Right of Way Dedication (select as appropriate)

Sec. 6.3.1.D.(1)(b)1. For Public Streets. "[All streets and right of way shown on this plat or name specifically if less than all] are hereby dedicated for the use and benefit of the public."

Sec. 6.3.1.D.(1)(b)2. For Non-Public Streets. "[All streets and right of way shown on this plat or name specifically if less than all] are hereby dedicated privately to the [entity name]. All public authorities and their personnel providing services to the subdivision are granted an easement for access. The Board of County Commissioners of Marion County, Florida, shall have no responsibility, duty, or liability whatsoever regarding such streets. Marion County is granted an easement for emergency maintenance in the event of a local, state, or federal state of emergency wherein the declaration includes this subdivision or an emergency wherein the health, safety, or welfare of the public is deemed to be at risk."

Sec. 6.3.1.D.(1)(b)3. For Cross Access Easements. "All parallel access easements shown on this plat are hereby dedicated for the use and benefit of the public, and maintenance of said easements is the responsibility of [entity name]."

Sec. 6.3.1.D.(1)(c)1&2 Utility Easements, select as appropriate:

1."[All utility easements shown or noted or name specifically if less than all] are dedicated [private or to the public] for the construction, installation, maintenance, and operation of utilities by any utility provider."

2."[All utility tracts or identify each tract as appropriate] as shown are dedicated [private or to the public] for the construction and maintenance of such facilities."

Sec. 6.3.1.D.(1)(d)1.2.3. Stormwater easements and facilities, select as appropriate:

- 1."[All stormwater and drainage easements as shown or noted or name specifically if less than all] are dedicated [private or to the public] for the construction and maintenance of such facilities."
- 2."[All stormwater management tracts or identify each tract as appropriate] as shown are dedicated [private or to the public] for the construction and maintenance of such facilities."
- 3. When any stormwater easement and/or management tract is not dedicated to the public or Marion County directly, the following statement shall be added to the dedicated language: "Marion County is granted the right to perform emergency maintenance on the [stormwater easement and/or management tract, complete accordingly] in the event of a local, state, or federal state of emergency wherein the declaration includes this subdivision or an emergency wherein the health, safety, or welfare of the public is deemed to be at risk." Sec. 6.3.1.D.(1)(f). If a Conservation Easement is required the following shall be provided: "A conservation easement [as shown or on tract and identify the tract, complete accordingly] is dedicated to [the Board of County Commissioners of Marion County, Florida or entity name, if not Marion County] for the purpose of preservation of [listed species, habitat, Karst feature and/or native vegetation, complete accordingly]."
- 2 DEPARTMENT: LUCURR LAND USE CURRENT REVIEW

REVIEW ITEM: 6.12.12 - [Sidewalks Internal/External Provided?]

STATUS OF REVIEW: INFO

REMARKS: Sidewalk are required for all residential development. A waiver may be requested through the DRC process.

#### 3 DEPARTMENT: LSCAPE - LANDSCAPE DESIGN AND IRRIGATION

REVIEW ITEM: 6.13.3 D(4) - Landscaping of private stormwater management facilities

STATUS OF REVIEW: INFO

REMARKS: How will stormwater runoff be addressed?

## 4 DEPARTMENT: DOH - ENVIRONMENTAL HEALTH

REVIEW ITEM: Total Flow STATUS OF REVIEW: INFO

REMARKS: .47acres x 1500gpd (for wells) = 705gpd authorized sewage flow

Each building is 3 bedrooms (300gpd estimated flow) Will need 1200gal tank (300gpd +75 +75 =450gpd)

#### 5 DEPARTMENT: DOH - ENVIRONMENTAL HEALTH

REVIEW ITEM: Available Area STATUS OF REVIEW: INFO

REMARKS: Will need a minimum of 1,125sqft for both systems depending on soils.

### 6 DEPARTMENT: DOH - ENVIRONMENTAL HEALTH

REVIEW ITEM: Additional Health comments

STATUS OF REVIEW: INFO

REMARKS: Will need septic permit for each system through the Department of Health in Marion County

Will need well permits for each well through the Department of Health in Marion County

### 7 DEPARTMENT: ENGIN - DEVELOPMENT REVIEW

REVIEW ITEM: 2.12.4.K - List of approved waivers, conditions, date of approval

STATUS OF REVIEW: INFO

REMARKS: 9/5/24-Add waivers if requested in the future

7/12/24 - Add waivers if requested in the future

### 8 DEPARTMENT: ZONE - ZONING DEPARTMENT

REVIEW ITEM: 2.20.1.A - When any of the Minor Site Plan thresholds are exceeded, a Major Site Plan is

required

STATUS OF REVIEW: INFO

REMARKS: 6972 sq ft impervious 34.1%

### 9 DEPARTMENT: ZONE - ZONING DEPARTMENT

REVIEW ITEM: 2.12.10- Show any known easements existing or proposed i.e. ingress or egress, landscape,

or conservation

STATUS OF REVIEW: INFO

REMARKS: No easements called out.

### 10 DEPARTMENT: ZONE - ZONING DEPARTMENT

REVIEW ITEM: 2.12.27 - Show location of outside storage areas

STATUS OF REVIEW: INFO REMARKS: None shown

### 11 DEPARTMENT: ZONE - ZONING DEPARTMENT

REVIEW ITEM: 2.12.21/6.3.1.C(10) - Land use and zoning on project and on adjacent properties shown

STATUS OF REVIEW: NO

REMARKS: Please show for subject property and adjacent properties on an aerial of the site and surrounding area.

υ

#### 12 DEPARTMENT: ZONE - ZONING DEPARTMENT

REVIEW ITEM: 2.12.32 - Modified environmental assessment or exemption if information is available to the county to indicate no habitat or existence of endangered species or vegetation (Article 6, Division 5, Sec. 6.5.4)

STATUS OF REVIEW: NO

REMARKS: An environmental assessment report or exemption must be provided.

### 13 DEPARTMENT: LSCAPE - LANDSCAPE DESIGN AND IRRIGATION

REVIEW ITEM: 2.12.18 - All trees 10" DBH and larger

STATUS OF REVIEW: NO

REMARKS: Plan states no existing trees, plan also shows two existing trees being preserved - please clarify -

2024 MCPA aerial does not show existing trees

### 14 DEPARTMENT: LSCAPE - LANDSCAPE DESIGN AND IRRIGATION

REVIEW ITEM: 6.7.4 - Shade tree requirements

STATUS OF REVIEW: NO

REMARKS: shade trees to be 3.5" cal. min, plans shows 3"

### 15 DEPARTMENT: LSCAPE - LANDSCAPE DESIGN AND IRRIGATION

REVIEW ITEM: 6.7.6 - Tree removal submittal requirements

STATUS OF REVIEW: NO

REMARKS: pending clarification

### 16 DEPARTMENT: LSCAPE - LANDSCAPE DESIGN AND IRRIGATION

REVIEW ITEM: 6.7.8 - Protected tree replacement requirements

STATUS OF REVIEW: NO

REMARKS: If no trees exist, no mitigation is required

### 17 DEPARTMENT: LSCAPE - LANDSCAPE DESIGN AND IRRIGATION

REVIEW ITEM: 6.7.9 - Replacement trees; general requirements.

STATUS OF REVIEW: NO

REMARKS: If no mitigation is required, no replacement is required

### 18 DEPARTMENT: LSCAPE - LANDSCAPE DESIGN AND IRRIGATION

REVIEW ITEM: 6.8.6 - Buffers STATUS OF REVIEW: NO

REMARKS: 1. show required groundcovers in ALL buffers, Liriope is on schedule, show on plan and provide quantity. 2 Waiver required for buffer width reduction for south and east boundaries 3. Show ornamental trees in south buffer 4. area on se boundary is missing buffer, please provide. 5. East and south buffers do not meet 50% planted are requirements

### 19 DEPARTMENT: LSCAPE - LANDSCAPE DESIGN AND IRRIGATION

REVIEW ITEM: 6.19.3 - Outdoor lighting plan requirements

STATUS OF REVIEW: NO

REMARKS: will there be outdoor lighting? if so a photometric plan is required

### 20 DEPARTMENT: LUCURR - LAND USE CURRENT REVIEW

REVIEW ITEM: 2.12.16/6.5 - [EALS or EALS-ER provided?]

STATUS OF REVIEW: NO

REMARKS: This area has a very high occurrence of Gopher Tortoise burrows. Please include a letter from a certified biologist or environmental scientist stating that there are no active burrows on site.

# 21 DEPARTMENT: LUCURR - LAND USE CURRENT REVIEW

REVIEW ITEM: 6.5 & 6.6 - Habitat Preservation/Mitigation Provided?

STATUS OF REVIEW: NO

REMARKS: This area has a very high occurrence of Gopher Tortoise burrows. Please include a letter from

a certified biologist or environmental scientist stating that there are no active burrows on site.



# Marion County Board of County Commissioners

AR#31762

Office of the County Engineer

412 SE 25th Ave. Ocala, FL 34471 Phone: 352-671-8686 Fax: 352-671-8687

# DEVELOPMENT REVIEW COMMITTEE WAIVER REQUEST FORM

	Date: 09/30/24 Parcel Number(s): 9025-0639-01	Permit Number: 2024052300 & 2303
Α.	. PROJECT INFORMATION: Fill in below as applicable:	
	Project Name: Dimovski Duplexes 2024 Subdivision Name (if applicable): Silver Springs Shores Unit 25	Commercial Residential
	Unit_25Block_639Lot_01Tract	
В.	PROPERTY OWNER'S AUTHORIZATION: The property owner's signature	authorizes the applicant to act on the
	owner's behalf for this waiver request. The signature may be obtained by email	
	owner, or original signature below.	
	Name (print):_ Branko Dimovski	
	Signature:	
	Mailing Address: 4295 SE 120 Street	City:Belleview
	State: Florida Zip Code: 34420 Phone # 352-219-3282	
	Email address: branko1@comcast.net	
C.	<ul> <li>APPLICANT INFORMATION: The applicant will be the point of contact dur all correspondence.</li> <li>Firm Name (if applicable): Contact Nam</li> </ul>	ng this waiver process and will receive e: Branko Dimovski
	Mailing Address: 4295 SE 120 Street	City:_Belleview
	State: Florida Zip Code: 34420 Phone # 352-219-3282	
	Email address: branko1@comcast.net	
D.	WAIVER INFORMATION:  Section & Title of Code (be specific):  Reason/Justification for Request (be specific):  1.The US Fish & Wildlife Service endangered species list What purpose does it serve to protect an animal that  2. My family has owned this property since 2003, there are no tortoises and I had a serve to protect an animal that	s has taken the Gopher Tortoise off the is not endangered? ve the grass cut on the property.
	3. In 2019,I had cleared the land for a duplex I was planning to build (Permit# 20	J19062282), but did not proceed.
Red	EVELOPMENT REVIEW USE: ecceived By: Unit of Date Processed: 10 4 24 CF Project # 202	4070025 AR#31762
Zoı		r Family Division: Yes □ No □ acation Required: Yes □ No □

3

# NEW RESIDENTIAL DUPLEX

**FOR** 

# **BRANKO & HEATHER DIMOVSKI**

**45 IUNIPER PASS** MARION COUNTY, FLORIDA

**BUILDING CODES** 

FACILITY DESCRIPTION

BUILDING AND SITE INFORMATION

BUILDING HEIGHT

15'-2" (1 STORY) ACTUAL HEIGHT -

BUILDING AREA TABULATION

SOIL BEARING CAPACITY

TYPE OF CONSTRUCTION

TYPE V-B, UNSPRINKLERED OCCUPANCY CLASSIFICATION & LOAD

CLASSIFICATION -RESIDENTIAL

DESIGN CRITERIA				
DESIGN WIND SPI	130 MPH			
RISK CATEGORY				
EXPOSURE CATEG	C +0.18 & -0.18			
INTERNAL WIND O				
ALL COMPONENTS INCLUDING DOORS AND WINDOWS SHALL BE DESIGNED TO THE FOLLOWING PRESSURE				
EFFECTIVE AREA	E (PSF)			
SQ. FT.	OUT	IN		
10	22.1	-29.6		
20 21.1		-27.6		
50	19.8	-25.0		
100	18.8	-23.0		

STRUCTURAL LOADS

20 P.S.F. REDUCIBLE 2 P.S.F. 40 P.S.F 130 M.P.H., 3 SEC GUST ROOF LIVE LOADS -COLLATERAL LOAD -FLOOR LIVE LOADS -

101 M.P.H. 29.8 P.S.F. @ 33-0" MEAN ROOF HT.

FIRE RESISTANCE OF COMPONENTS

INTERIOR BEARING WALLS - MR
EXTERIOR BEARING WALLS - MR
COLUMINS AND BEAMS - MR
ROOF/CELING ASSEMBLY - MR
TENANT SEPARATION WALL - 1 HR

PLUMBING REQUIREMENTS

EGRESS REQUIREMENTS

EXTERIOR DOOR MANUFACTURER:

WINDOW MANUFACTURER:

ROOF SHINGLE MANUFACTURER:

GARAGE DOOR MANUFACTURER:

ATTIC VENTILATION REQUIREMENTS

EAVE: 88.67 LF X 9/144/LF = 5.54 SF RIDGEVENT: 14.67 LF X .167" = 2.45 SF

NOTE: 2 SF OF OFF RIDGE VENTING IS TO BE PROVIDED IN ADDITION TO SOFFIT AND RIDGE VENTILATION

**DESIGN CODE REFERENCE** 

BULDING COST \_ FLORID, RESIDETIVA, BILLUING COST \_ 8H DITION (2023)

RECURRING COST \_ PHINONAL PRINCE COSTS \_ 2025 ERTION

FLUERING COST \_ FLORIDA RELIGIOR COSTS \_ 8H DITION (2023)

RECHANICAL COST \_ FLORIDA PREF PREVENTION COST \_ 8H DITION (2023)

FIRE COST \_ FLORIDA PREF PREVENTION COST \_ 8H DITION (2023)

GAS COST \_ FLORIDA PREF ASS COST \_ 9H DITION (2023)

GAS CODE - FLORIDA FUEL GAS CODE - 8th EDITION (2023)
NFPA 58 - LUQUETED PETROLLIUM GAS - (2020)
NFPA 72 - MATIONAL FIRE ALARM CODE (2019)
NFPA 72E - AUTOMATIC DETECTION DEVECTS (LATEST EDITION)
NFPA 101 - LIFE SAFETY CODE (2021)
NFPA 80 - FIRE DOORS AND WINDOWS (2019)

JOHA
ACI-318 - BUILDING REQUIREMENTS FOR REINFORCED CONCRETE (2019)
AISC CODE OF STANDARD PRACTICE (MANUAL OF STEEL CONSTRUCTION, 9th EDITION,
S-310 SPECIFICATIONS FOR THE DESIGN FABRICATION AND ERECTION OF STEEL

**CONSTRUCTION NOTES** 

GOI 1 THE CENERAL COMPACTOR SHALL YEARY ALL DIMENSIONS PRIDE TO JABRICTION OR STATT OF CONSTRUCTION.

WHICH THE CENERAL COMPACTOR SHALL PROVIDE ALL MESSINES INCCESSANT TO PROTECT THE STRUCTURE, ALL
ALL DE RESPONSIBLE FOR ALL CONSTRUCTION. HE SHALL SUPERVISE AND DEET THE WORK
AND DE RESPONSIBLE FOR ALL CONSTRUCTION.

SOS - THE GENERAL CONTRACTOR SHALL COORDINATE ARCHITECTURAL, MECHANICAL AND ELECTRICAL DEARWINGS FOR
ANCHORS, DEMERS, SUPPORTS, OR ANY OTHER TERMS WHICH MAY ETERS TEMPLIFIED, ADMINISS.

#### FOLINDATION

TO A COMMONE DISTRIBUTE, SETUES MATERIALS AND SOFT ABEAS IN SOIL SHALL BE REMOVED AND THE SOIL PREVAIL FOR A ALLOWAGE BEARM PRESSURE OF 22009M.
FOR A SHOULD THE CONTRACTOR DISCOVER ANY CONDITION WHICH COULD PREVAIN THE ATTAINMENT OF THE STATED DESIGN PRESSURE, HE SHALL NOTHY THE ACRITICTO OR REMORETS MINEDIATY.

SLAB ON GRADE

JACO D'N CHANDE I TO 95% MINIMUM MAX DRY DENSITY (MODIFIED PROCTOR, ASTM D1557-58T OPTIMUM MOSTURE CONTROL), SOLL COMPACTION SMALL BE FIELD CONTROLLED BY A REPRESENTATIVE FROM A QUALIFIED LABORATOR APPROVED BY THE MEMIERE, EACH MEXTER OF FILL SMALL FOR TO FLECT OF AND SMALL BE COMPACTED PROOR TO THE FLACEMENT OF THE MEXT FILL LATER.

OF 3- ALL FLOOR SLASS SMALL BE FRACED UPON A \*\*CHILLED SMALL DATE FOR FINE GRADING.

#### CONCRETE AND REINFORCING

CONCRETE AND REINFORCHING

OI - CONCRETE WORK SHALL GOVERN TO ALC STANDARD BUILDING CODE REQUIREMENTS FOR REINFORCED

CONCRETE (ACI 318-19).

OZ - CONCRETE SHALL MAYE A MINHUM 28 DAY STRENGTH AS FOLLOWS:

SLABS ON GARDE - 3000, AND CONCRETE BEAMS - 3000, BIND SHALL LAP A MINHUM OF 25" AT ALL JOINTS.

OS - ALL REEMS HALL CONFORM TO ASTIL-815, BOAGE 60, AND SHALL LAP A MINHUM OF 25" AT ALL JOINTS.

SLABS WITH FIRER MESH OR WELDED WHIE FARRIC SHALL CONFORM TO ASTIL A-185-02.

OS - COVER FOR ALL REINFORMS STELL SHALL BE AS FOLLOWS (UMILES NOTES):

SLABS ON GARDE - 1-1/2" OI STRENGU'S

ALL BEAMS - 1-1/2" OI STRENGU'S

OS - VERTICAL REBAM WALL REINFORCHING SHALL BE A STANDARD HOOK WITH A 25" PROJECTION ABOVE SLAB AND MAYE A MERGAMENT "EMERGEMENT."

MOI - ALL MASONRY CONSTRUCTION SHALL COMFORM TO ACI STANDARD BUILDING CODE REQUIREMENTS FOR MASONRY STRUCTURES (ACI 530-14).
MOZ - ALL CONCRETE BLOCKS SHALL CONFORM TO ASTM C 90. 128 DAY STRENGTH MUST EQUAL 2000phi, FM SHALL

MO2 – ALL CONCRETE BLOCKS SHALL CONFORM TO ASTM C 90. 128 DAY STRENGTH MUST EQUAL 2000psi, FM SHALL EQUAL 1500psi JADD IN A RINNING BORD.

MO3 – ALL MORTAR SHALL BE TYPE S OR M.

AS – ALL MORTAR SHALL BE TYPE S OR M.

A SHINDAY OF (1) \$6 REDAY WITH A CONTINUOUS HORIZONTAL BOND BEAM GROUTED SOULD AND REINFORCE WITH A MINIMUM OF (1) \$6 REDAY WITH A 25° OVERLAR AT EACH JOINT.

AS MINIMUM OF (1) \$6 REDAY WITH A 125° OVERLAR AT EACH JOINT.

AS ON STRENGTH OF 300psi AMD A GROUND SLUMP HOT LESS THAN 5°. REPROREE WITH A MINIMUM OF (1) \$5 VERTICAL REGAR WITH A MINIMUM 25° OVERLAR A EACH JOINT.

MO6 – GROUT FOR FILLED CILLS SHALL BE FOUNED OR FINIMETO IN LIFTS NOT TO EXCEED 10°-0" IN HEIGHT AMD SHALL BE CONSCIULTED AT HTE THE OF FOUNED OR FINIMETO IN LIFTS THAN 10°C, DESCRIPTION OF THE OF THE OFF FOUNDER OF POUNDER OF WITHOUT IN LIFTS THAN 5°C.

MINIMUM COLOR OF THE TOTAL OF THE THE OFF FOUNDER OF WITHOUT IN LIFTS THAN 5°C.

MINIMUM COLOR OF THE TOTAL OF THE THE OFF FOUNDER OF THE OFF THE OFF

MO7 - PROVIDE KNOCKOUTS IN CMU AT TH BASE OF EACH FILLED CELL TO ALLOW VISUAL VERIFICATION OF COMPLETE GROUT PENETRATION.

#### STRUCTURAL LUMBER

101 - ALL STRUCTURAL AND LOAD BEARING WALLS SHALL HAVE A UNRIGHD TO 7 1200001.
102 - WALLS HORRER THAN 9 - 0" SHALL HAVE INTERDIBLET BERDOME SAFED NOT GREATER THAN 72" APART.
103 - ALL LOAD BEARING WALLS SHALL HAVE A DOUBLE SYP No.2 TOP PLATE.
104 - ALL WOOD IN CONTACT WITH MASORNY OR CONCRETE SHALL BE PRESSURE TREATED.

#### STRUCTURAL STEEL

501 - STEEL WORK SHALL CONFORM TO THE AISC SPECIFICATIONS FOR THE DESIGN, FABRICATION AND ERECTION OF STRUCTURAL STEEL FOR BUILDINGS (USE THE LATEST EDITION).

#### DRAWING INDEX ARCHITECTURAL

- UL DESIGN DETAILS

A1.0 - FLOOR PLAN

- FOUNDATION PLAN / DETAILS
- ROOF FRAMING PLAN / DETAILS

E1.0 - ELECTRICAL PLAN / DETAILS

DEVELOPED BY
DIMOVSKI PROPERTIES
BRANKO DUPLEXS

David P. King, Jr

ARCHITECT

DRAWING ISSUE PERMIT MARCH 2024 REVISED: 1 CODE UPDATE

RESIDENTIAL DUPLEX

ON VACANT LAND BRANKO & HEATHER DIMOVSKI


DRAWN BY: CHECKED BY:

APPROVED BY: ARCHITECT'S PROJECT Mo.:

BUILDING CODE DATA

SHEET HUMBER

C1

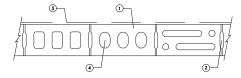

### DESIGN No. U905

BEARING WALL RATING - 2 HR NON-BEARING WALL RATING - 2 HR

#### HORIZONTAL SECTION

2. MORTAR – BLOCKS LAID IN FULL BED OF MORTAR, NOM 3/8 IN THICK, OF NOT LESS THAN 2-1/4 AND NOT MORE THAN 5-1/2 PARTS OF CLEAN, SWARP SAND TO ONE PART PORTLAND CEMENT AND NOT MORE THAN FITY PERCENT HORBATED LINE (95 CEMENT VOLUME). VERTICAL JOHN'S STAGGERED.


3. PORTLAND CEMENT STUCCO OR GYPSUM PLASTER – ADD 1/2 MR TO CLASSIFICATION IF USED, WHERE COMBUSTAGE BEHABERS ARE FRAMED IN WALL, PLASTER OR STUCCO MUST BE APPLIED ON THE FACE OPPOSITE FRAMEN TO ACHIEVE A MAX CLASSIFICATION OF 1–1/2 MR. ATTACHED TO CONCRETE BLOCK (TEM 1).

4. LOOSE MASONRY FILL— IF ALL CORE SPACES ARE FILLED WITH LOOSE, DRY, EXPANDED SLAG, EXPANDED CLAY OR SHALE (ROTARY KILN PROCESS), WATER REPELIANT YERMICULTE MASONRY FILL INSULATION OR SILICOME TREATED PERILT LOOSE FILL INSULATION, ADD 2 HR TO CLASSIFICATION.

5. FOAMED PLASTIC\* - (OPTIONAL - NOT SHOWN) - 1-1/2 IN THICK MAX, 4 FT WIDE SHEATHING ATTACHED TO CONCRETE BLOCKS (ITEM 1).
CELOTEC CORP. - TYPE THERMAX

\* BEARING THE UL CLASSIFICATION MARKING

Design No. U338 Nonbearing or Bearing Wall Rating - 1 HR. (See Items 2 and 2A) Finish Rating One Layer of Wallboard - Min. 20 Min. Two Layers of Wallboard - Min. 59 Min

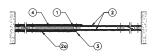


#### HORIZONTAL SECTION

HORIZONTAL SECTION

1. Wood Sluds – hom 2 by 3 or 2 by 4 in., flot wire, appeared 24 in. O.C. max, effectively firenthepped.

2. Gypsum Boord\* – For Hosboering Well Realing – One layer of 5/1° in. oppiles horizonther for the oppiles horizonther or the oppiles have been or the oppiles when the oppiles with the oppiles with

\*Bearing the UL Classification Mark.

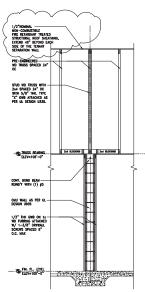

1HR TENANT SEPARATION WALL

DRAWING ISSUE PERMIT MARCH 2024

David P. King, Jr ARCHITECT

REGISTRATIONS: STATE OF FLORIDA STATE OF GEORGIA PROJECT

DEVELOPED BY
DIMOVSKI PROPERTIES
BRANKO DUPLEXS

NEW RESIDENTIAL DUPLEX ON VACANT LAND FOR BRANKO & HEATHER DIMOVSKI

45 JUNIPER PASS MARION COUNTY, FLORIDA

DRAWN BY: CHECKED BY: APPROVED BY:

ARCHITECT'S PROJECT No.:


SHEET TITLE: **UL DESIGN** 

SHEET HUMBER


LS1



WINDOW SCHEDULE							
MARK	DESCRIPTION	ROUGH OPENING BLOCK	HEADER	SQ. FTG	DESIGN PRESSURES		
1	25 SH	37-3/4" x 63"	LT4	16.5156	21.1/-27.6		
2	24 SH	37-3/4" x 50-5/8"	LT4	33.2556	19.8/-25.0		
VERIFY ALL WINDOW SIZES, TYPES, MANUFACTURER AND LOCATION W/ OWNER PRIOR TO CONSTRUCTION.							
VERIFY A	VERIFY ALL ROUGH OPENING DIMENSIONS WITH WINDOW MANUFACTURER.						
00000000	CONDUNTE III RETUEDS MAIN IMIES DIAN IND SCHEDIIE						

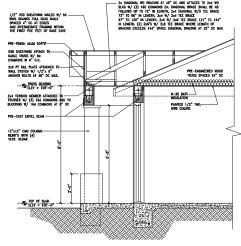

1 COVERED ENTRY SECTION
Scale: 1/2" = 1'.0"

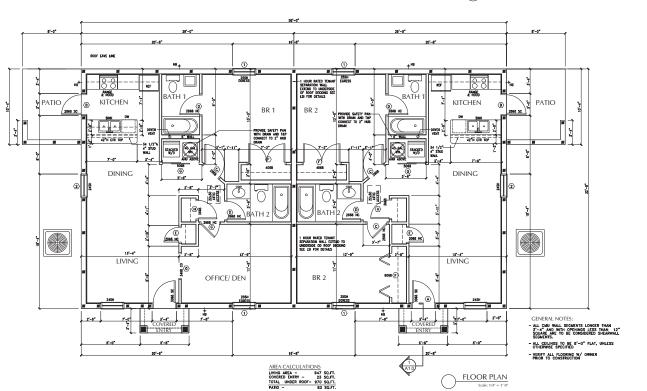

DRAWING ISSUE PERMIT MARCH 2024



David P. King, Jr ARCHITECT

REGISTRATIONS: STATE OF FLORIDA STATE OF GEORGIA PROJECT

DEVELOPED BY
DIMOVSKI PROPERTIES
BRANKO DUPLEXS

NEW RESIDENTIAL DUPLEX ON VACANT LAND FOR

BRANKO & HEATHER DIMOVSKI 45 JUNIPER PASS MARION COUNTY, FLORIDA

DRAWN BY:

CHECKED BY:

APPROVED BY:


ARCHITECT'S PROJECT No.:


SHEET TITLE:

FLOOR PLAN


SHEET HUMBER

A1.0

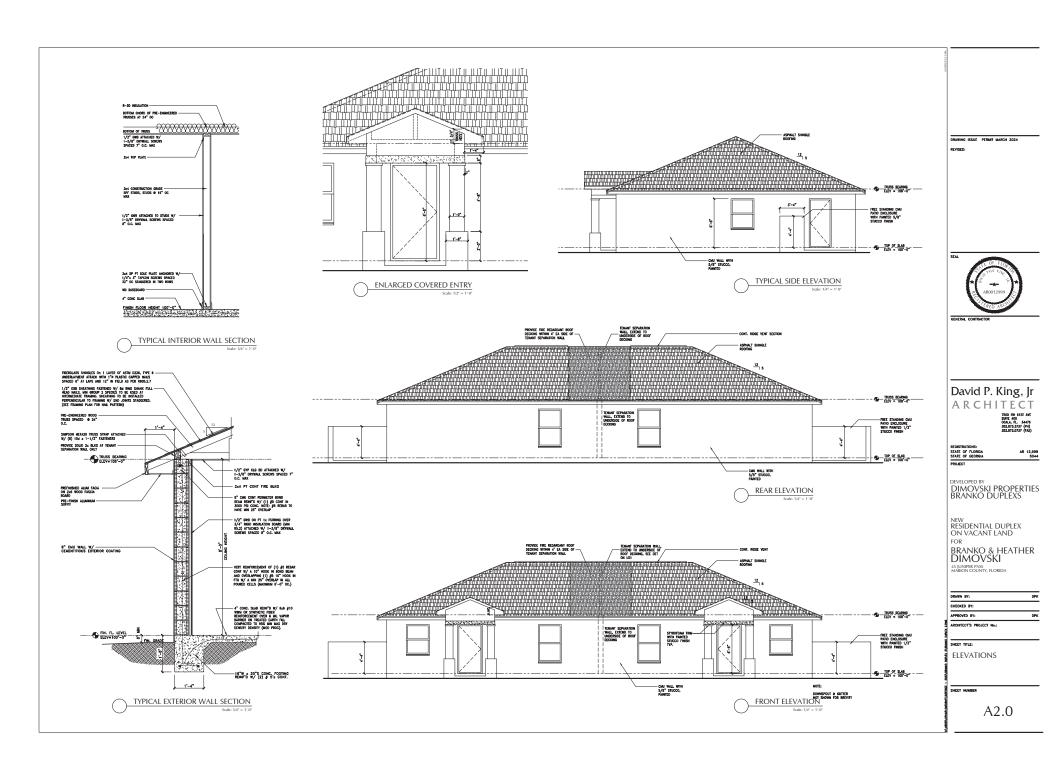


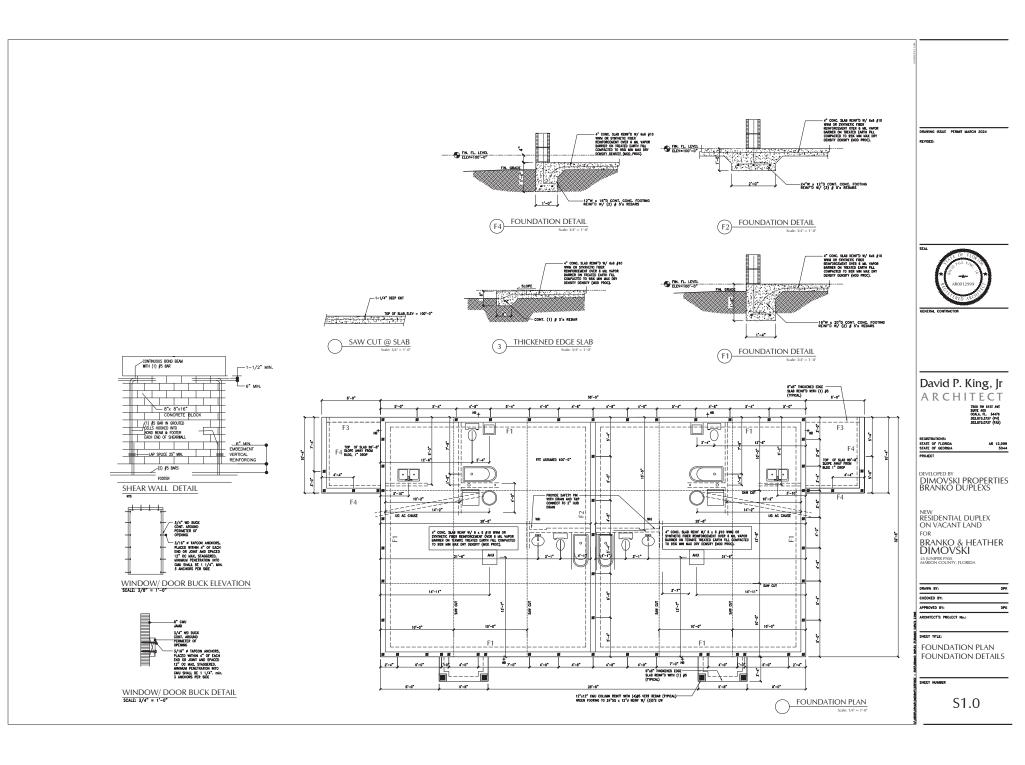



MARK	UPLIFT	ANCHOR	FLORIDA APPROVAL #			
TYP, CMU	1450	(1) SIMPSON META20 FASTENED W/ (7) 10d x 1-1/2" COMMONS	FL11473.18			
TYP, WOOD	1140	(1) SIMPSON HIOA FASTENED W/ (18) 10dx 1 1/2" NAILS EACH	FL11478.4			
TRUSS ENGINEERING NOTES						
TRUSS LAYOUT SHOWN DEPICTS DESIGN INTENT ONLY. TRUSS MFR SHALL SUBMIT SHOP DRAWINGS SIGNED AND SEALED BY A FLORIDA REGISTERED ENGINEER. UPLIFT ANCHORAGE AND LOADS MUST BE PROVIDED W/TRUSS PROFILES.						
PROVIDE A CONTINUOUS LOAD	PATH BETW	EEN FOUNDATION AND ROOF SYSTEM. ALL CONNECTORS SMALL BE INSTALLED PER MRF ERWISE SPECIFIED ON DRAWINGS SMALL BE IN ACCORDANCE W/ FBCR 2017, SIXTH EDIT				
PROVIDE A CONTINUOUS LOAD	PATH BETW S NOT OTH	EEN FOUNDATION AND ROOF SYSTEM. ALL CONNECTORS SHALL BE INSTALLED PER MEF ERWISE SPECIFIED ON DRAWINGS SHALL BE IN ACCORDANCE W/ FBCR 2017, SIXTH EDII				

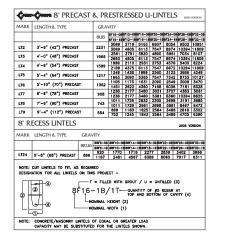



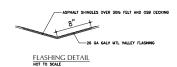

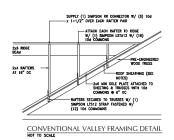

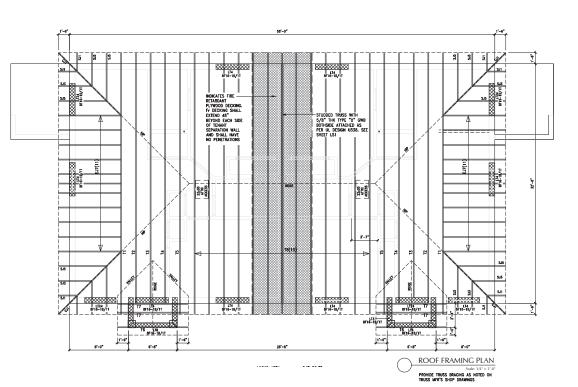

DRAWING ISSUE PERMIT MARCH 2024



David P. King, Jr ARCHITECT 700 50 4 153 AFE 5041, Rt. 34478 502,373,375 (Pd) 502,373,375 (Pd)

REGISTRATIONS: STATE OF FLORIDA STATE OF GEORGIA

DEVELOPED BY
DIMOVSKI PROPERTIES
BRANKO DUPLEXS

NEW RESIDENTIAL DUPLEX ON VACANT LAND FOR BRANKO & HEATHER DIMOVSKI

45 JUNIPER PASS MARION COUNTY, FLORIDA

DRAWN BY:
CHECKED BY:
APPROVED BY:
ARCHITECT'S PROJECT No.:


SHEET TITLE:

ROOF FRAMING PLAN


SHEET HUMBER

S2.0

<del>+</del>	SURFACE MOUNTED LIGHT	\$	SINGLE SWITCH
ю	WALL MOUNTED LIGHT	\$5	3-WAY SWITCH
-Ø**	RECESSED CAM LIGHT	\$4	4-WAY SWITCH
<b>©</b> ##	VAPOR-PROOF RECESSED	\$ <sup>RC</sup>	REMOTE CONTROL SWITCH
<b>[6]</b>	VAPOR-PROOF HEAT LAMP	□D8	DOOR BELL CONNECTION
-₽-	EXHAUST FAM W/ LIGHT	[]CH	DOOR CHIME
	SINGLE BULB FLOURESCENT LIGHT	⊲nν	TY OUTLET
===	DOUBLE BULB FLOURESCENT LIGHT	⊲m	PHONE OUTLET
<del>کی</del>	TRACK LIGHTING	⊲ov	DATA OUTLET
ρŽ	EXTERIOR FLOODLIGHT	•	THERMOSTAT
<u>*</u> ^	EXTERIOR PATH LIGHT	(BBC)-1	CUT-OFF SWITCH
Ф	110 OUTLET	$\bowtie$	200 AMP ELEC. PANEL
•	220 OUTLET	Λ	METER
Φ***	WATER-PROOF OUTLET	0	SNOKE AND CARBON WONOXIDE DETECTOR
ф <sup>ог</sup>	GROUND FAULT OUTLET	N	GARBAGE DISPOSAL
0	GFI FLOOR OUTLET		CEILING FAN W/ LIGHT

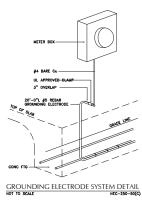

PROVIDE INTERSYSTEM BONDING TERMINATION BLOCK IN ACCORDANCE WITH FRBC CHAPTER 3609.3

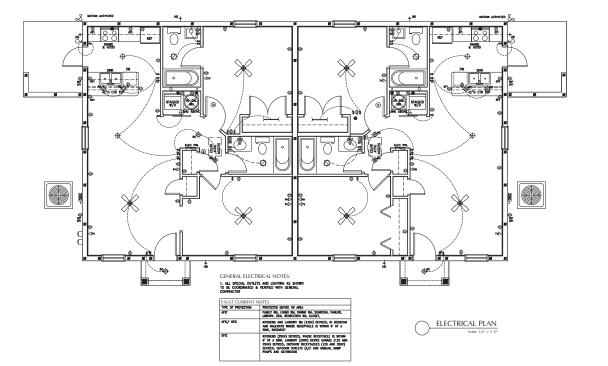

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David P. King, Jr ARCHITECT 7000 SW 611ST AVE SWATT AND

STATE OF FLORIDA STATE OF GEORGIA

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DIMOVSKI PROPERTIES
BRANKO DUPLEXS

NEW RESIDENTIAL DUPLEX ON VACANT LAND FOR BRANKO & HEATHER DIMOVSKI 45 ILUIPER PASS MARRON COUNTY, FLORIDA


DRAWN BY:
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APPROVED BY:
ARCHITECT'S PROJECT Mo.:

SHEET TILE:

ELECTRICAL PLAN

SHEET HUMBER

E1.0

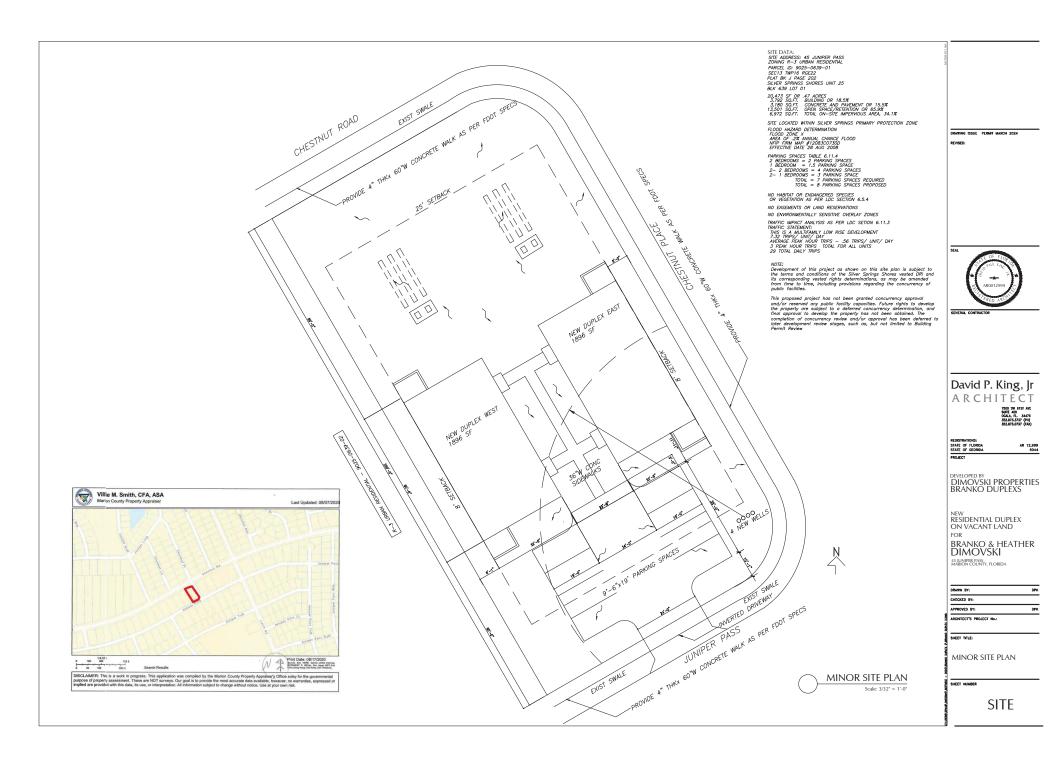



#### IRRIGATION KEY

AUTOMATIC CONTROLLER (ELECTRIC) IN LOCK BOX, PROVIDE ELECTRIC W/ RAIN SENSOR

HB HOSE BIB

\_\_\_\_ SCH.40 PVC SLEEVE.

\_ CLASS 160 LATERAL LINE, SIZED TYP. 1/2"



→ ZONE CONTROL VALVE (LOW FLOW + PRESSURE REGULATOR)

OOO BACKFLOW PREVENTER

\* XERI-BUG EMITTER, 2 GPH 30 PSI

17 BUBBLERS

3/4" DRIP POLY PIPE SYSTEM
SOD NOT IRRIGATED, HAND WATER UNTIL ESTABLISHED 1163 SF IRRIGATED



Table 1. Watering schedule for newly planted trees and shrubs

Weeks after planting: Watering frequency:

1-2 Daily Every 2-3 days 3-12

Until established\* Weekly

\* See Table 2 for tree establishment time. Shrubs establish in 1-2 years.

Newly planted shrubs are considered established when their root spread equals the spread of the above-ground canopy.

Establishment times for trees increases with tree size. Trunk caliper at planting time can be used to determine the time it takes for roots to establish (Table 2).

Table 2. Establishment time and watering volume for newly planted trees.

Caliper (inches) Root establishment time for trees (years) Water applied during each

	irrigation (g	jalions)
1	1.5	1-1.5
2	3	2-3 3
3	4.5	3-4.5
4	6	4-6
5	7.5	5-7.5
6	9	6-99

\*apply 1-1 1/2 gallons per inch of stem caliper at each watering

- TYPE OF AUTOMATED SYSTEM = ELECTRIC CONTROLLER IN OUTDOOR LOCKING CABINET OR INDOORS.

  TYPE AND SIZE OF ELECTRICAL WIRE = TO BE DETERMINED AT FOR VALVES
  BACKTLOW PREVENTION DEVICE = FEBCO 850 DOUBLE CHECK OR PER COUNTY REQUIREMENTS COUNTY
  REQUIREMENTS
- REQUIRED OPERATING PRESSURE = 30 PSI / 20 GPM
  DESIGN OPERATING PRESSURE OF IRRIGATION SYSTEM = 30 PSI
  PLACEMENT OF RAIN SENSOR WILL BE MOUNTED IN OPEN AREA CLOSE TO CONTROLLER LOCATION.
- 7. WATER REQUIREMENTS PER ZONE = PROVIDE 1/4" WATER PER ZONE/DAY (1-3/4"/WEEK), COMPLY WITH DISTRICT WATERING RESTRICTIONS BUBBLERS ZÓNES (EACH)= RUN TIME 15 MIN., 7 DAYS (FIRST YEAR)= 30 GALLONS/DAY SPRAY HEADS= RUN TIME 15 MIN., 7 DAYS (FIRST YEAR)= 540 GALLONS/DAY MAX.

  8. SEE DETAIL SHEET FOR INSTALLATION SPECIFICATIONS AND DETAILS.

- I. METER TO MANE A TOTALIZING WAITER METER INSTALLED AT WATER SOURCE FOR IRROGATION.

  2. NEW IRRIGATION PHING MAY BE REVISED DEPRIONIS ON LOCATION OF WILL.

  3. WATER SOURCE TO BE WELL WAITER AND MAINAIRE TO BE ADJUSTED TO COMMENT ZONE CONTROLLERS.

  A A COMPLETE, SELF-CERTIFICATION CHECKLIST, AS WELL AS A CLEAR AND ACCURATE AS-BULL SKETCH, TO BE A COMPLETE,

  SELF-CERTIFICATION CHECKLIST, AS WILL AS A CLEAR AND ACCURATE AS-BULL SKETCH, TO BE SUBMITTED AND ACCEPTED

  BY THE COUNTY, AND

  IN THE FINAL INSPECTION AND LANDSCAPE/IRRIGATION RELEASE HAS BEEN RECEIVED ON THE COUNTY HAS THE FINAL

  MERCETION AND LANDSCAPE/IRRIGATION RELEASE HAS BEEN RECEIVED ON THE COUNTY HAS CONDUCTED AND CERTIFIED A

  FINAL INSPECTION.



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David P. King, Jr ARCHITECT

DIMOVSKI PROPERTIES BRANKO DUPLEXS

NEW RESIDENTIAL DUPLEX ON VACANT LAND

BRANKO & HEATHER DIMOVSKI

45 JUNIPER PASS MARION COUNTY, FLORIDA

	DRAWN BY:	DPI
	CHECKED BY:	
	APPROVED BY:	DPI
1,200	ARCHITECT'S PROJECT No.:	


SHEET TITLE:

IRRIGATION PLAN


SITE

#### IRRIGATION NOTES


- 1. This schematic irrigation plan serves primarily as a guide. The Contractor shall be entirely responsible for proper coverage and operation of the systems, including changes from the plan as necessary to adjust for actual site conditions.
- 2. The Contractor shall be responsible for providing all labor, materials, and accessories required for complete irrigation systems meeting the performance requirements outlined herein.
- 3. All work shall be installed in accordance with the regulations of the local, county, or other governing authorities. Fees for all permits, inspections, and impact fees required shall be included as work required.
- 4. The water source shall be well water. Design data shall be verified by the Contractor prior to
- 5. A rain sensor device, Mini-Clik II, or approved equal, shall be installed for each controller
- 6. All remote control valves, gate valves, ball valves, hose bibs and wire splices shall be installed in a suitable Ametek-type valve box of proper size as required for easy access to the valve. Valve boxes shall have a sump of 1 cf gravel. Valve boxes shall be set flush and sloped with the surrounding grade.
- 7. All PVC pipe in the system less than 2" O.D. except risers, shall be Class 160 PSI Polyvinyl Chloride solvent weld pipe conforming to the ASTM-D2466, Type 1, requirements, NSF
- 8. All PVC pipe in the system greater or equal to 2" O.D. and fittings shall be Schedule 40. Type 1, NSF approved conforming to the ASTM-D2466 requirements
- All wiring, if required, shall be U.L. U.F. wiring. A separate power wire shall be installed from the controller to each individual valve. Wiring shall be installed with main lines where possible; when not, it shall be installed in conduit. Waterproof wire connectors shall be used for controller wiring. Provide pressure compensating devices as necessary to reduce misting.
- 10. Verify the presence of all sleeving before commencing work. Where piping must pass under existing concrete or payement, it shall be jacked or jetted where possible. Only if impossible to get in place without cutting pavement, permission will be given by the Owner to cut paving. If this is necessary, all cutting and replacing of the paving to match the existing shall be included under this section of the specifications.
- 11. All PVC piping and wiring shall be installed in the trenches with a minimum of 12" of cover and a maximum depth of 24", except where specific permission is obtained from the Landscape Architect and/or Owner for less cover due to existing conditions. Where necessary because of landscaping, cover shall be as deep as required.
- 12. All flex pipe shall be buried to a depth of at least 4" (or covered with 3" of mulch) except where the tubing daylights over newly planted rootballs.
- 13. All emitters and flood bubblers shall be installed at the rootball and be minimally visable above the mulch.
- 14. The Contractor shall warrant the installation workmanship for a period of one year from date of job completion and retainage release. The Contractor shall further see to the fulfillment of all manufacturer's warranties and shall provide an Owner's Manuals. A reproducible as-built copied from the original showing all dimensioned. A reproducible as-built copied from the original showing all dimensioned system components shall be required for final job acceptance.
- 15. Irrigation System to include backflow device. Rainsensor to be installed at controller.

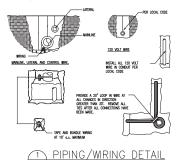

SCALE: NOT TO SCALE

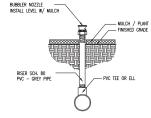



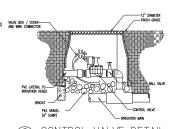

WRE SHALL NOT TOUCH OR RUB ADJACENT BRANCHES OR TRUNCS.

REMOVE ALL GUYS WITHIN ONE YEAR OF INSTALLATION

TREE PLANTING DETAIL

PLANTING PIT TO BE TWICE DIAMETER OF ROOT BALL (MIN. 6" EACH SIDE)

SHRUB PLANTING

· GROUND LINE OF ROOT BAL

FORM SAUCER WITH



#### LANDSCAPE NOTES

IF TREE HAS INDIVIDUAL BUBBLER OR DRIP IRRIGATION

FORM SAUCER WITH 3" CONTINUOUS RING

OMPACTED PLANTING SOL BELOW ROOTBALL

- 1. All plants shall be Florida No. 1 or better, as outlined under Grades and Grades and and Standards for Nursery Plants, Division of Plant Industries. State of Florida, latest edition.
- All work shall be performed in accordance with standard and accepted nursery practices in a workmanlike manner.
- 3. The Landscape Contractor shall be responsible for finish grading all areas of the site. Rough grade will be within 2" of finish grade. The Landscape Contractor shall be responsible for any grade disturbed by his
- 4. The Landscape Contractor shall be responsible for the thorough removal of existing weeds and grass in the areas to be planted, including application(s) of appropriate herbicides before and after plant installation.
- 5. Soil used for planting shall consist of two parts of the existing soil and one part domestic peat moss (or sandy fill in heavy soils), mixed with two lbs. fertilizer per cubic yard. Fertilizer shall be SLOW RELEASE for new plantings.
- 6. Terra-Sorb, or approved equal, shall be incorporated into the planting soil of all trees in sandy soils only at the following rates:
  - 15 gallon containers = one (3 oz.) Handy Pac 30 gallon containers = two (3 oz.) Handy Pacs Up to 3" caliper = one (3 oz.) Handy Pac 4" to 5" caliper = two (3 oz.) Handy Pacs Broadcast 1/2 throughout the planting pit; mix 1/2 with backfill. All plant beds shall be top-dressed with 3" of pine bark nuggets.
- 7. The Landscape Architect reserves the right to field locate or review flagged locations of any or all plant material.
- 8. All balled and burlapped trees shall be hardened-off at the supplier's for a minimum of 30 days prior to shipping. All suppliers must be approved by the Landscape Architect prior to delivery and installation of the trees; any tree which shows signs of stress shall be replaced immediately at no charge to the Owner.
- 11. Guaranty (from time of job completion and retainage release): Trees and shruhs = 1 year

David P. King, Ir 9. All trees will be staked per detail sheet or by another method approved by the Landscape Architect. Mulched tree rings shall encompass guys. 10. No substitutions shall be permitted without prior approval from the Landscape Architect.

120 GAL BLADDER TANK, AS SPECIFIED OPTIONAL OUTDOOR IRRIGATION CONTROLLER
OPTIONAL: PEDESTAL NOTE: REFER TO ELECTRICAL DRAWINGS FOR ELECTRICAL POWER, DISCONNECT AND TRANSFORMER FOR WELL AND PUMP SYSTEM W.P. JUNCTION BOX /4 x 4 CONCRETE POST IRRIGATION WELL AND PLINE MOTES WELL & PUMP CONTRACTOR SHALL PROVIDE ALL WORK AND MATERIALS FOR A COMPLETE WORKING SYSTEM FOR THE 2 1/2\*PIPE -2. ALL FITTINGS ABOVE GROUND SHALL BE GALVANIZED PIPE **W** 3. PUMP SYSTEM SHALL INCLUDE:

1 1/4" PRESSURE RELIEF VALVE PUMP START W/ CONTROLLERS
PUMP START W/ CONTROLLERS
PRESSURE GAUGE 0-100 P.S.L.
PROVIDE WELL WAITER OF THE QUALITY AND QUANTITY AS
PROVIDE WELL WAITER OF THE QUALITY AND QUANTITY AS
PROVIDED, WITH IROW PRESENT AT THE RATE OF LESS THAM
102 ABOUT POWER TO PUMP SYSTEM OBTAIN ALL NECESSARY PERMITS AND COMPLY WITH APPLICABLE REGULATIONS. LOCAL AND STATE. FRONT VIEW

SCALE: NOT TO SCALE

5. WELL & PUMP SYSTEM SHALL BE CHECKED FOR OPERATIONAL STATUS. /PUMP DETAIL

DO NOT INSTALL IRRIGATION SYSTEM BEFORE THE ABOVE TEST RESULTS HAVE BEEN ACCOMPLISHED AND APPROVED.

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ARCHITECT

DIMOVSKI PROPERTIES BRANKO DUPLEXS


NEW RESIDENTIAL DUPLEX BRANKO & HEATHER DIMOVSKI

45 JUNIPER PASS MARION COUNTY FLORIDA

DRAWN BY: CHECKED BY: APPROVED BY: ARCHITECT'S PROJECT No.

**DETAIL DRAWINGS** 

SITE

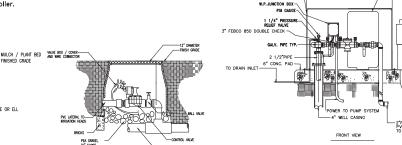

OF THE DISPOSAL OF WASTE MATERIALS, RIGIDING BUT NOT HALL CONDICTE, AND WORTHY WITHIN THE TREE PROTECTION 20



Updated every 24 hours



DISCLAIMER: This is a work in progress. This application was compiled by the Marion County Property Appraiser's Office soley for the governmental purpose of property assessment. These are NOT surveys. Our goal is to provide the most accurate data available, however, no warranties, expressed or implied are provided with this data, its use, or interpretation. All information subject to change without notice. Use at your own risk.