



SUBMITTAL SUMMARY REPORT 33561

PLAN NAME: WALMART #4368 SSS OCALA FUEL STATION	LOCATION: 34 BAHIA AVE OCALA,
APPLICATION DATE: 10/30/2025	PARCEL: 37491-001-00
DESCRIPTION:	

CONTACTS	NAME	COMPANY
Applicant	Matthew D'Angelo	CPH Consulting LLC
Engineer of Record	Matthew D'Angelo	CPH Consulting LLC

SUBMITTAL	STARTED	DUE	COMPLETE	STATUS
OCE: Plan Review (DR) v.5	05/13/2026	05/20/2026	05/13/2026	Approved
OCE: Plan Review (DR) v.4	04/30/2026	05/07/2026	05/13/2026	Requires Re-submit
OCE: Plan Review (DR) v.3	03/20/2026	03/27/2026	04/28/2026	Requires Re-submit
OCE: Plan Review (DR) v.2	02/02/2026	02/09/2026	02/16/2026	Requires Re-submit
OCE: Plan Review (DR) v.1	11/04/2025	11/26/2025	12/23/2025	Requires Re-submit


SUBMITTAL DETAILS

OCE: Plan Review (DR) v.5				
ITEM REVIEW NAME (DEPARTMENT)	ASSIGNED TO	DUE	COMPLETE	STATUS
Landscape (Plans) (Parks and Recreation)	Susan Heyen	05/20/2026	05/13/2026	Approved
<i>Comments</i> per email dated 5/13/26				

OCE: Plan Review (DR) v.4				
ITEM REVIEW NAME (DEPARTMENT)	ASSIGNED TO	DUE	COMPLETE	STATUS
Landscape (Plans) (Parks and Recreation)	Susan Heyen	05/07/2026	05/01/2026	Requires Re-submit
<i>Comments</i> Mounting heights of lights exceeds 30 foot maximum height of Code. Please revise or request waiver				

OCE: Plan Review (DR) v.3				
ITEM REVIEW NAME (DEPARTMENT)	ASSIGNED TO	DUE	COMPLETE	STATUS
911 Management (DR) (911 Management)	Caroline Dennison	03/27/2026	03/26/2026	Approved
<i>Corrections</i> Additional 911 Comments (Resolved) - Sheet C0.1 has the address listed as 34 Bahia Avenue, it should be TBD. Sheet C2.1 has the address listed as 34 Bahia Ave, it should be TBD.				

Environmental Health (Plans) (Environmental Health)	Evan Searcy	03/27/2026	03/26/2026	Approved
Fire Marshal (Plans) (Fire)		03/27/2026	03/20/2026	Approved
Growth Services Planning & Zoning (DR) (GS Planning and Zoning)	Kathleen Brugnoli	03/27/2026	03/23/2026	Approved
Landscape (Plans) (Parks and Recreation)	Susan Heyen	03/27/2026	03/24/2026	Requires Re-submit
<i>Comments</i> 1. Submit signed and sealed photometric plan with data table per LDC 6.19, 30' max mounting ht. 2. See landscape plans for markups				
OCE Design (Plans) (Office of the County Engineer)	William Poole	03/27/2026	03/23/2026	Requires Re-submit
<i>Corrections</i> 2.12.3 - Title block (Not Resolved) - 2.12.3 - Title block: Title block on all sheets denoting type of application; project name, location, county, and state; and date of original and all revisions				

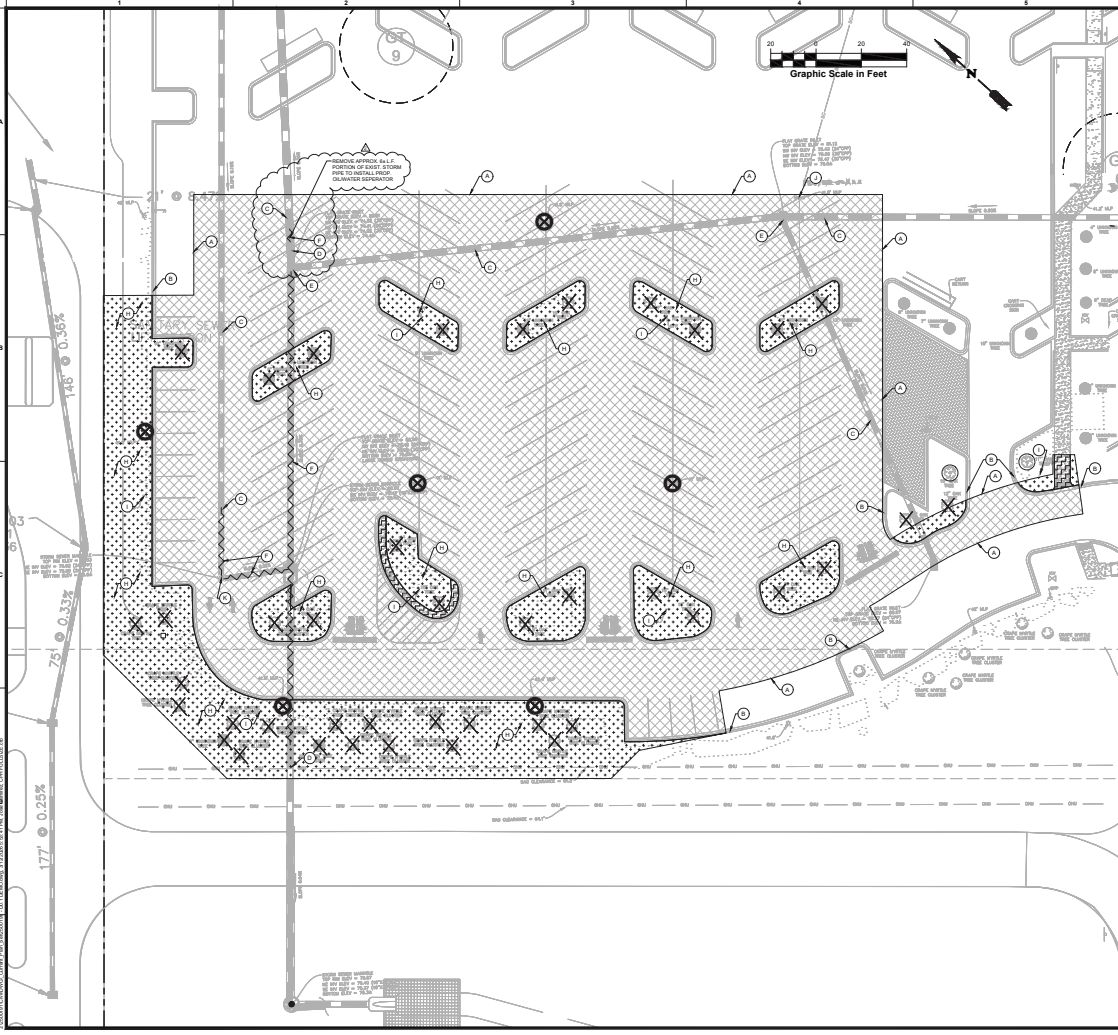

- DEMOLITION LEGEND**
- EXISTING FURNISH AND FIXTURES TO BE REMOVED
 - EXISTING CONCRETE GENERAL: FLOOR TO BE REMOVED
 - EXISTING CONCRETE GENERAL: WALLS TO BE REMOVED
 - EXISTING CONCRETE GENERAL: ROOF TO BE REMOVED
 - EXISTING METAL ROOF TO BE REMOVED
 - EXISTING METAL WALLS TO BE REMOVED
 - EXISTING METAL FLOOR TO BE REMOVED
 - EXISTING METAL ROOF TO BE REMOVED
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 - EXISTING METAL FLOOR TO BE REMOVED
 - EXISTING METAL ROOF TO BE REMOVED
 - EXISTING METAL WALLS TO BE REMOVED
 - EXISTING METAL FLOOR TO BE REMOVED
- DEMOLITION KEYNOTE LEGEND**
- KEYNOTE 1: EXISTING CONCRETE GENERAL: FLOOR TO BE REMOVED
 - KEYNOTE 2: EXISTING CONCRETE GENERAL: WALLS TO BE REMOVED
 - KEYNOTE 3: EXISTING CONCRETE GENERAL: ROOF TO BE REMOVED
 - KEYNOTE 4: EXISTING METAL ROOF TO BE REMOVED
 - KEYNOTE 5: EXISTING METAL WALLS TO BE REMOVED
 - KEYNOTE 6: EXISTING METAL FLOOR TO BE REMOVED
 - KEYNOTE 7: EXISTING METAL ROOF TO BE REMOVED
 - KEYNOTE 8: EXISTING METAL WALLS TO BE REMOVED
 - KEYNOTE 9: EXISTING METAL FLOOR TO BE REMOVED
 - KEYNOTE 10: EXISTING METAL ROOF TO BE REMOVED
 - KEYNOTE 11: EXISTING METAL WALLS TO BE REMOVED
 - KEYNOTE 12: EXISTING METAL FLOOR TO BE REMOVED

- DEMOLITION NOTES**
1. THE LOCATION OF ALL EXISTING UTILITIES SHOWN ON THIS PLAN HAVE BEEN DETERMINED FROM THE BEST INFORMATION AVAILABLE AND ARE SHOWN FOR THE CONVEYANCE OF THE CONTRACTOR. THE CONTRACTOR SHALL BE RESPONSIBLE FOR VERIFYING THE LOCATION OF ALL UTILITIES PRIOR TO THE START OF THE DEMOLITION. THE CONTRACTOR SHALL NOTIFY THE UTILITY COMPANIES FOR THE LOCATION OF ALL UTILITIES PRIOR TO THE START OF THE DEMOLITION.
 2. THE CONTRACTOR SHALL PROTECT ALL EXISTING UTILITIES AND EQUIPMENT PRIOR TO THE DEMOLITION. THE CONTRACTOR SHALL BE RESPONSIBLE FOR THE PROTECTION AND REPAIR OF EXISTING UTILITIES AND EQUIPMENT AS SHOWN ON THE DRAWINGS AND DESCRIBED HEREIN.
 3. ANY EXISTING UNDERGROUND STRUCTURES AND PIPES NOT TO BE REMOVED MUST BE COMPLETELY REVEALED AND MAINTAINED AT A MINIMUM OF 18" ABOVE THE STRUCTURE. THE CONTRACTOR SHALL USE APPROVED FLAGGING TO MARK THESE AREAS. FLAG SHALL BE OF CLEAR PINE BARK AMBIT CLASS A AND SHALL BE PLACED IN 12" IF UNDER EXISTING CONCRETE TO AT LEAST 18" OF THE EXISTING CONCRETE SURFACE (AS SHOWN ON THE DRAWINGS).
 4. ALL EXISTING STRUCTURES, FOUNDATIONS, SLABS, STAIRS, AND OTHER AREAS NOTED ON THE DRAWINGS SHALL BE DEMOLISHED AND REMOVED BY THE CONTRACTOR. REMOVE NO STRUCTURE SUBSTANTIALLY AS A SINGLE BULKY MASS FROM THE PROPERTY.
 5. ALL EXISTING ROOFING, SIDING AND UTILITY SYSTEMS ARE NOT TO BE REMOVED AT THE EXACT LOCATION, OR AS THE ONLY REMOVED MATERIAL OCCURRING ON THE SITE. REMOVE EXISTING ROOFING AND SIDING WITH PROTECTIVE AND ALL EXISTING UTILITY SYSTEMS SHALL BE REMOVED WITH THE EXISTING UTILITY COMPANY. REMOVE ALL EXISTING UTILITY SYSTEMS WITH THE EXISTING UTILITY COMPANY. REMOVE ALL EXISTING UTILITY SYSTEMS WITH THE EXISTING UTILITY COMPANY. REMOVE ALL EXISTING UTILITY SYSTEMS WITH THE EXISTING UTILITY COMPANY.
 6. EXISTING UTILITIES SHALL BE PROTECTED AND MAINTAINED AS SHOWN ON THE DRAWINGS AND DESCRIBED HEREIN. THE CONTRACTOR SHALL BE RESPONSIBLE FOR THE PROTECTION AND REPAIR OF EXISTING UTILITIES AND EQUIPMENT AS SHOWN ON THE DRAWINGS AND DESCRIBED HEREIN.
 7. PROVIDE ADEQUATE PROTECTION FOR PERSONS AND PROPERTY AT ALL TIMES. EXCEPT THE WORKMAN, A WARNING SIGN SHALL BE PLACED AT ALL TIMES TO PROTECT THE PUBLIC FROM THE WORK. THE CONTRACTOR SHALL BE RESPONSIBLE FOR THE PROTECTION AND REPAIR OF EXISTING UTILITIES AND EQUIPMENT AS SHOWN ON THE DRAWINGS AND DESCRIBED HEREIN.
 8. THE CONTRACTOR SHALL BE RESPONSIBLE FOR THE PROTECTION AND REPAIR OF EXISTING UTILITIES AND EQUIPMENT AS SHOWN ON THE DRAWINGS AND DESCRIBED HEREIN.
 9. THE CONTRACTOR SHALL BE RESPONSIBLE FOR THE PROTECTION AND REPAIR OF EXISTING UTILITIES AND EQUIPMENT AS SHOWN ON THE DRAWINGS AND DESCRIBED HEREIN.
 10. DISPOSAL.
 11. PAVEMENT REMOVAL.
 12. THE CONTRACTOR SHALL BE RESPONSIBLE FOR THE PROTECTION AND REPAIR OF EXISTING UTILITIES AND EQUIPMENT AS SHOWN ON THE DRAWINGS AND DESCRIBED HEREIN.
 13. THE CONTRACTOR SHALL BE RESPONSIBLE FOR THE PROTECTION AND REPAIR OF EXISTING UTILITIES AND EQUIPMENT AS SHOWN ON THE DRAWINGS AND DESCRIBED HEREIN.
 14. THE CONTRACTOR SHALL BE RESPONSIBLE FOR THE PROTECTION AND REPAIR OF EXISTING UTILITIES AND EQUIPMENT AS SHOWN ON THE DRAWINGS AND DESCRIBED HEREIN.
 15. THE CONTRACTOR SHALL BE RESPONSIBLE FOR THE PROTECTION AND REPAIR OF EXISTING UTILITIES AND EQUIPMENT AS SHOWN ON THE DRAWINGS AND DESCRIBED HEREIN.
 16. THE CONTRACTOR SHALL BE RESPONSIBLE FOR THE PROTECTION AND REPAIR OF EXISTING UTILITIES AND EQUIPMENT AS SHOWN ON THE DRAWINGS AND DESCRIBED HEREIN.
 17. ALL EXISTING UTILITIES WITHIN THE P.L.O. SHALL BE REVEALED, RELOCATED OR RECONNECTED AT THE CONTRACTOR'S EXPENSE. THE CONTRACTOR SHALL BE RESPONSIBLE FOR THE PROTECTION AND REPAIR OF EXISTING UTILITIES AND EQUIPMENT AS SHOWN ON THE DRAWINGS AND DESCRIBED HEREIN.

cph
www.cphcorp.com
Building Better
Communications Together
3801 Walker Street, Suite 101
Tempe, AZ 85288
PH: 602.988.2253

Plans Prepared By:
CPL, LLC
A Full Service A & E Firm

Professional Engineer
L. L. LEMMON
No. 125007
STATE OF ARIZONA
Professional Engineer

Site Location: State of Arizona
Professional Engineer License
No. 125007
This work was prepared by the
engineer and is subject to the
jurisdiction of the State
of Arizona.

Client:	Walmart
Project:	Walmart Supercenter
Job No.:	2500181
Date:	01-28-20
Drawn by:	J. Anderson
Checked by:	M. Granger
Type of Application:	Major Site Plan



DEMOLITION PLAN

Walmart
WALMART STORE # 2500181
1777 W. WILSON AVENUE
TAMPA, FL 33613

Sheet No. **D0.1**

THIS SHEET NOT VALID FOR
CONSTRUCTION WITHOUT
COMPLETE SET OF PLANS

Always call 811 two full business days before you dig.
Sunshine 811.com
www.sunshine811.com

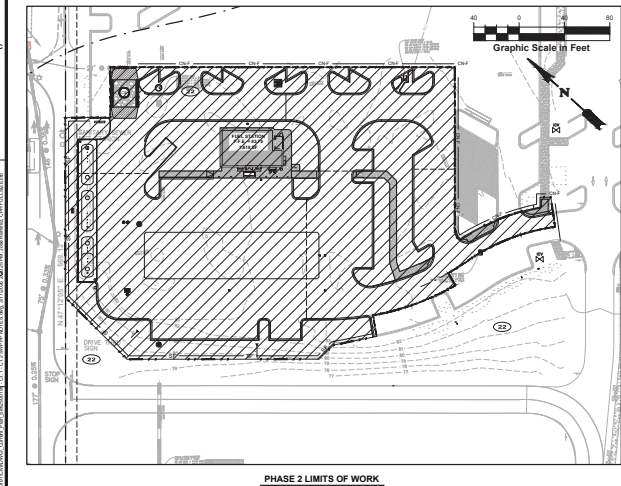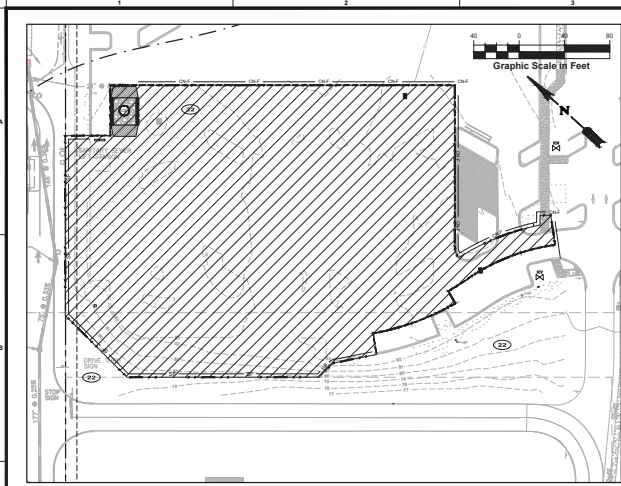

LEGEND

LIMITS OF DISTURBANCE
 ■ 1' ■ PERMITTED LIMITS OF DISTURBANCE
 ▨ LIMITS OF WORK

SWPPP IMPLEMENTATION SEQUENCE

NOTE: UPON IMPLEMENTATION AND INSTALLATION OF THE FOLLOWING AREAS: TRAILER, PARKING, LAY DOWN, PORTA-POTTY, WHEEL WASH, CONCRETE WAREHOUSING AREA, TIE-UP AND MATERIAL STORAGE AREAS, CONTAINERS, SOLID WASTE CONTAINERS, ETC. IMMEDIATELY DENOTE THEM ON THE SITE MAPS AND NOTE ANY CHANGES IN LOCATION AS THEY OCCUR THROUGHOUT THE CONSTRUCTION PROCESS. IN ADDITION, WHITE ALL AREAS WHERE FILL IS IMPORTED FROM OR SOIL IS EXPORTED TO ON THE SITE MAPS.

NOTE: DOWN SLOPE PROTECTIVE MEASURES MUST ALWAYS BE IN PLACE BEFORE SOIL IS DISTURBED. ACTIVITIES ARE PROHIBITED IN THE ORDER OR SEQUENCE IN WHICH THEY ARE REQUIRED TO BE COMPLETED.

- PHASE 1**
1. PRECONSTRUCTION MEETING MUST BE HELD PRIOR TO ANY LAND DISTURBANCE, INCLUDING BMP INSTALLATION. THIS MEETING SHALL INCLUDE THE DESIGN ENGINEER, GENERAL CONTRACTOR, THE LOCAL INSPECTOR, AND ALL CONTRACTORS AND ALL HOLDERS INCLUDING UTILITY PROVIDERS OR UTILITY CONTRACTORS EMPLOYED BY THE PRIMA AND SECONDARY PERMITTEE MUST ATTEND.
 2. INSTALL THE SWPPP INFORMATION SIGN AND POST REQUIRED DOCUMENTS NEAR THE PLANNED CONSTRUCTION EXIT, AND WITHIN EASY ACCESS TO THE GENERAL PUBLIC WITHIN 5 FEET OF THE SITE.
 3. STAKE OUT THE LID (WHERE STAKING IS NOT POSSIBLE/PRACTICAL, THE LID MUST BE CONSPICUOUSLY AND PROMINENTLY MARKED TO DENOTE THE MINIMUM LID MUST REMAIN CONSPICUOUSLY MARKED THROUGHOUT THE ENTIRE CONSTRUCTION PROJECT.
 4. INSTALL PERIMETER SEDIMENT CONTROL BMPs IN THE VICINITY OF, AND DOWN GRADIENT FROM, THE LOCATION OF THE PLANNED CONSTRUCTION EXIT, CONSTRUCTION OFFICE TRAILER, AND TEMPORARY PARKING AND STORAGE AREAS. CLEAR ONLY THE MINIMUM AREA ABSOLUTELY NECESSARY TO INSTALL THESE PERIMETER CONTROL BMPs.
 5. INSTALL STABILIZED CONSTRUCTION EXITS AND SET THE PROJECT OFFICE TRAILER.
 6. INSTALL REMAINING PERIMETER SEDIMENT CONTROL BMPs, AS SHOWN ON THE SITE MAP, CLEAR ONLY THE MINIMUM AREA NECESSARY TO INSTALL PERIMETER CONTROL BMPs.
 7. PREPARE TEMPORARY PARKING AND STORAGE AREA.
 8. HALT ALL ACTIVITIES.
 9. CONTACT THE CEC TO PERFORM INSPECTION AND CERTIFICATION OF BMPs. BMP CERTIFICATION MUST OCCUR BEFORE FURTHER PRECONSTRUCTION MEETING. THIS SHOULD BE SCHEDULED IN ADVANCE, IN ANTICIPATION OF THE EXPECTED DATE WHEN THE ABOVE SEQUENCE ITEMS WILL BE COMPLETED.
 10. ALL EXCEPTIONS NOTED ON THE BMP CERTIFICATION FORM MUST BE ADDED AS REFERENCES WITHIN THE BMP CERTIFICATION FORM AND RESOLVED WITHIN 24 HOURS. BMPs MUST NOT BE CERTIFIED IF ONE OR MORE OF THE EXCEPTIONS WILL NOT BE RESOLVED WITHIN 24 HOURS OF THE BMP CERTIFICATION BY THE CEC.
 11. IF THE CEC IS UNABLE TO CERTIFY THAT SITE CONDITIONS ARE PER PLAN AND SWPPP BINDER, THE CERTIFICATION OF BMPs MUST BE RESCHEDULED. THE STORMWATER PRECONSTRUCTION MEETING MAY ONLY OCCUR AFTER BMPs CAN BE CERTIFIED.
 12. GENERAL CONTRACTOR SHALL SCHEDULE AND CONDUCT THE STORMWATER PRECONSTRUCTION MEETING WITH THE GC, OWNER'S CONSTRUCTION MANAGER, AGENCIES AND SUBCONTRACTORS BEFORE PROCEEDING WITH CONSTRUCTION.
 13. STORMWATER INSPECTION REPORTS IN THE ONLINE SWPPP REPORTING SYSTEM PROVIDED BY THE OWNER MUST START ON THE NEXT BUSINESS DAY AFTER THE SITE BMP & PRECONSTRUCTION MEETING CERTIFICATION IS MOND-CERTIFIED BY THE CEC.

- PHASE 2**
14. BEGIN GRADING THE SITE.
 15. START CONSTRUCTION OF BUILDING PAD AND STRUCTURES.
 16. TEMPORARILY STABILIZE, THROUGHOUT CONSTRUCTION IMMEDIATELY FOLLOWING THE COMPLETION OF THE MOST RECENT LAND DISTURBING/GRADING ACTIVITY, ANY DISTURBED AREAS, INCLUDING MATERIAL STOCKPILES THAT ARE SCHEDULED OR LIKELY TO REMAIN INACTIVE FOR LEAST 90 DAYS.
 17. IMMEDIATELY PERMANENTLY STABILIZE AREAS TO BE VEGETATED AS THEY ARE BROUGHT TO FINAL GRADE.
 18. INSTALL UTILITY PROTECTION, STORM SEWER, CURBS AND GUTTERS.
 19. INSTALL BMP RAP AROUND OUTLET STRUCTURES AS EACH OUTLET STRUCTURE IS INSTALLED.
 20. INSTALL INLET PROTECTION AT ALL STORM SEWER STRUCTURES AS EACH INLET STRUCTURE IS INSTALLED.
 21. PREPARE SITE FOR PAVING.
 22. PAVE SITE.
 23. INSTALL APPROPRIATE INLET PROTECTION DEVICES FOR PAVED AREAS AS WORK PROGRESSES, PER BMP DETAILS.
 24. COMPLETE GRADING AND INSTALLATION OF PERMANENT STABILIZATION OVER ALL AREAS INCLUDING OUTLETS AND PONES.
 25. OBTAIN CONCURRENCE FROM THE OWNER CONSTRUCTION MANAGER (CM) THAT THE SITE HAS BEEN FULLY STABILIZED AND ALL CONSTRUCTION HAS BEEN COMPLETED, THEN:
 26. REMOVE ALL REMAINING TEMPORARY EROSION AND SEDIMENT CONTROL BEST MANAGEMENT PRACTICES (BMPs), AND
 27. STABILIZE ANY AREAS NOT COVERED BY THE REMOVAL OF TEMPORARY BMPs.
 28. CONTINUE INSPECTIONS AND REPORTS UNTIL THE CM FINAL INSPECTION REPORT, MARKED READY TO TERMINATE PERMIT, IS SIGNED BY THE CONSTRUCTION MANAGER AND SUBMITTED VIA THE ONLINE SWPPP REPORTING SYSTEM PROVIDED BY THE OWNER.

NOTE: THE GENERAL CONTRACTOR MAY COMPLETE CONSTRUCTION-RELATED ACTIVITIES CONCURRENTLY, ONLY IF ALL PRECEDING BMP, AND STABILIZATION ACTIVITIES HAVE BEEN COMPLETELY INSTALLED. BMP-RELATED STOPS IN THE ABOVE SEQUENCE ARE BOLD FOR CLARITY.

CONTRACTOR NOTE:

WHEN IN CLOSE PROXIMITY, THE LIMITS OF DISTURBANCE SHALL FOLLOW THE BUILDING CURB, FENCE LINES, ETC. UNLESS OTHERWISE INDICATED. LIMITS OF DISTURBANCE SHOWN OUTSIDE BUILDING, CURB, FENCE LINES, ETC. FOR CLARITY PURPOSES.

- MINIMIZATION OF DISTURBED AREAS:**
1. CONTRACTOR SHALL MANAGE CONSTRUCTION ACTIVITIES TO REDUCE EROSION AND RETAIN SEDIMENT AND OTHER POLLUTANTS IN THE SOIL AT THE CONSTRUCTION SITE.
 2. CONTRACTOR SHALL MINIMIZE THE TIME BARE SOIL IS EXPOSED.
 3. CONTRACTOR SHALL MINIMIZE SITE DISTURBANCE BY MINIMIZING THE EXTENT OF GRADING AND CLEARING TO EFFECTIVELY REDUCE SEDIMENT YIELD.
- NOTE TO GC: OWNER HAS AUTHORITY AT ANY TIME TO LIMIT SURFACE AREA OF ERODIBLE EARTH MATERIAL EXPOSED BY CLEARING AND GRADING, EROSION, BORROW AND EMBANKMENT OPERATIONS AND TO DIRECT THE GC TO PROVIDE IMMEDIATE PERMANENT OR TEMPORARY POLLUTION CONTROL MEASURES.

NOTE TO GENERAL CONTRACTOR:

PRIOR TO CONSTRUCTION, GC MUST CLEARLY DELINEATE AND MARK OFF AREAS IDENTIFIED IN THE SWPPP OR IN THE FIELD, TO BE PROTECTED (SUCH AS NATURAL BUFFERS, TREES, HABITATS OF ENDANGERED/THREATENED SPECIES, HISTORIC PROPERTIES, ETC.).



DEVELOPER/OWNER:
 WALMART STORES EAST, L.P.
 MAIL STOP 5570
 2001 SE 10TH STREET
 BENTONVILLE, AR
 72716-5570
 479-204-1195

SITE OPERATOR/GENERAL CONTRACTOR:

SUPERINTENDENT:

IMPORTANT: GC MUST SIGN ALL PLAN SHEETS AND ANY NEW PLAN SHEETS ISSUED BY THE CEC.

cph
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 Building Better Communities Together
 3801 Walker Street, Suite 102
 Tampa, FL 33606
 Ph: 813.288.8253

Plans Prepared By:
 CPH, LLC
 A Full Service A & E Firm

STATE OF ARIZONA
 PROFESSIONAL ENGINEER
 LICENSE No. 12007
 EXPIRES 12/31/2024
 JAMES L. LEMMON
 3000 North Central Expressway
 Suite 100
 Phoenix, AZ 85018
 This seal has been digitally signed and certified to meet the requirements of the Arizona State Board of Engineers and Architects.


Drawn: J. Anderson
 Checked: M. Grogan
 Job No.: 2020181
 Date: 04-26-24
 Type of Application: Major Site Plan

Walmart
 WALMART STORES EAST, L.P.
 2001 SE 10TH STREET
 BENTONVILLE, AR 72716-5570
 479-204-1195

SWPPP IMPLEMENTATION SEQUENCE AND LIMITS OF WORK

THIS SHEET NOT VALID FOR CONSTRUCTION WITHOUT COMPLETE SET OF PLANS

Sheet No. **C1.2**

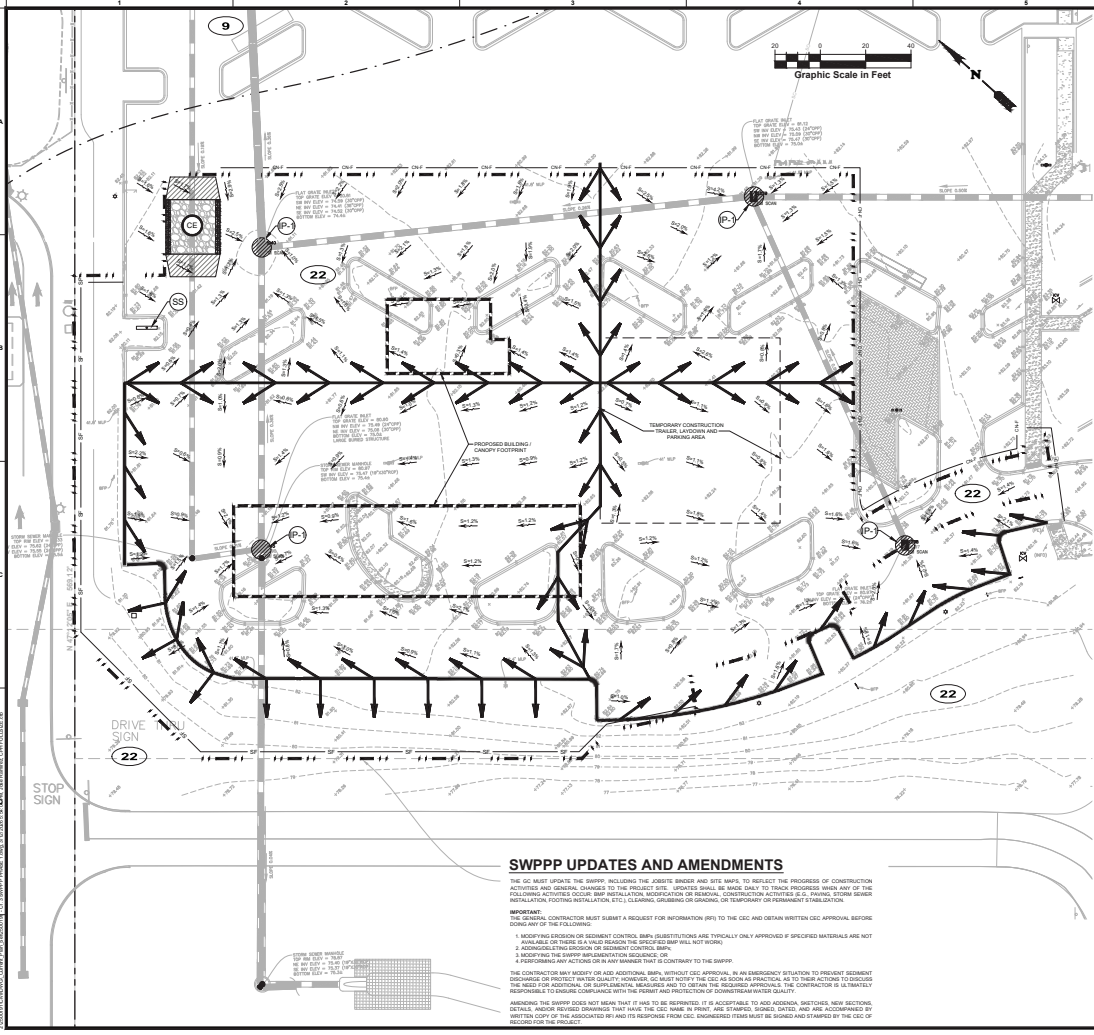

LEGEND

SITE FEATURES

- PROPERTY LINE
- SOIL BOUNDARY
- LIMITS OF DISTURBANCE
- EXISTING CONTOUR
- EXISTING STORM PIPE
- DIRECTION OF OVERLAND FLOW
- LIMITS OF DRAINAGE SUB-BASIN
- BARRICADE AT ALL ENTRANCE LOCATIONS WITH TEMPORARY CONSTRUCTION ACCESS

EROSION DETAILS

- SF SEDIMENT BASIN
- SP SEDIMENT BASIN WITH WIRE BASKETS
- CE TEMPORARY CONSTRUCTION SILT FENCE
- SE SWPPP OR CONSTRUCTION SILT FENCE
- PS INLET PROTECTION FILTER SOCK

EROSION NOTES

- 9 SOIL TYPE: HERRING SAND, 0 TO 1 PERCENT SLOPES
- 22 SOIL TYPE: CANTLER SAND, 0 TO 3 PERCENT SLOPES

CONTRACTOR NOTE:
WHEN IN CLOSE PROXIMITY, THE LIMITS OF DISTURBANCE SHALL FOLLOW THE BUILDING, CURB, FENCE LINES, ETC., UNLESS OTHERWISE INDICATED. LIMITS OF DISTURBANCE SHOWN OUTSIDE BUILDING, CURB, FENCE LINES, ETC. FOR CLARITY PURPOSES.

- MINIMIZATION OF DISTURBED AREAS:**
- CONTRACTOR SHALL MANAGE CONSTRUCTION ACTIVITIES TO REDUCE EROSION AND RETAIN SEDIMENT AND OTHER POLLUTANTS IN THE SOIL AT THE CONSTRUCTION SITE.
 - CONTRACTOR SHALL MINIMIZE THE TIME BARE SOIL IS EXPOSED.
 - CONTRACTOR SHALL MINIMIZE SITE DISTURBANCE BY MINIMIZING THE EXTENT OF GRADING AND CLEARING TO EFFECTIVELY REDUCE SEDIMENT YIELD.
- NOTE TO GC/OWNER HAS AUTHORITY AT ANY TIME TO LIMIT SURFACE AREA OF ERODIBLE EARTH MATERIAL EXPOSED BY CLEARING AND GRUBBING, EXCAVATION, BORROW AND EMBANKMENT OPERATIONS AND TO DIRECT THE GC TO PROVIDE IMMEDIATE PERMANENT OR TEMPORARY POLLUTION CONTROL MEASURES.**

NOTE TO GENERAL CONTRACTOR:
PRIOR TO CONSTRUCTION, GC MUST CLEARLY DELINEATE AND MARK OFF AREAS IDENTIFIED IN THE SWPPP OR IN THE FIELD TO BE PROTECTED (SUCH AS, NATURAL BUFFERS, TREES, HABITATS OF ENDANGERED/THREATENED SPECIES, HISTORIC PROPERTIES, ETC.).

SWPPP UPDATES AND AMENDMENTS

THE GC MUST UPDATE THE SWPPP, INCLUDING THE JOB SITE BINDER AND SITE MAPS, TO REFLECT THE PROGRESS OF CONSTRUCTION ACTIVITIES AND ANY CHANGES TO THE PROJECT. SWPPP UPDATES ARE TYPICALLY ONLY APPROVED IF SPECIFIED MATERIALS ARE NOT AVAILABLE OR THERE IS A VALID REASON THE SPECIFIED SWPPP WILL NOT WORK.

IMPORTANT: THE GENERAL CONTRACTOR MUST SUBMIT A REQUEST FOR INFORMATION (RFI) TO THE CEC AND OBTAIN WRITTEN CEC APPROVAL BEFORE DOING ANY OF THE FOLLOWING:

- MODIFYING EROSION OR SEDIMENT CONTROL BARRIERS/STRUCTURES ARE TYPICALLY ONLY APPROVED IF SPECIFIED MATERIALS ARE NOT AVAILABLE OR THERE IS A VALID REASON THE SPECIFIED SWPPP WILL NOT WORK.
- ADDED/DELETED ANY SECTION OF SEDIMENT CONTROL SWPPP.
- MODIFYING THE SWPPP IMPLEMENTATION SCHEDULE OR.
- PERFORMING ANY ACTION OR IN ANY MANNER THAT IS CONTRARY TO THE SWPPP.

THE CONTRACTOR MAY MODIFY OR ADD ADDITIONAL SWPPP WITHOUT CEC APPROVAL IN AN EMERGENCY SITUATION TO PREVENT SEDIMENT ESCAPES OR PROTECT WATER QUALITY. HOWEVER, GC MUST NOTIFY THE CEC AS SOON AS PRACTICABLE AS TO THESE ACTIONS TO DISCUSS THE NEED FOR ADDITIONAL OR SUPPLEMENTAL MEASURES AND TO OBTAIN THE NECESSARY APPROVALS. THE CONTRACTOR IS ULTIMATELY RESPONSIBLE TO ENSURE COMPLIANCE WITH THE PERMIT AND PROTECTION OF DOWNSTREAM WATER QUALITY.

AMENDING THE SWPPP DOES NOT MEAN THAT IT HAD TO BE REPRINTED. IT IS ACCEPTABLE TO ADD ADDITIONAL SKETCHES, NEW SECTIONS, DETAILS, AND/OR REVISIONS DRAWINGS THAT HAVE THE CEC NAME IN FRONT, ARE DATED, AND ARE ACCOMPANIED BY WRITTEN COPY OF THE ASSOCIATED RFI AND ITS RESPONSE FROM CEC. ENGINEERED ITEMS MUST BE SIGNED AND STAMPED BY THE CEC OF RECORD FOR THE PROJECT.

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72716-2570
479-204-1195

SITE OPERATOR/GENERAL CONTRACTOR:

SUPERINTENDENT:

IMPORTANT: GC MUST SIGN ALL PLAN SHEETS AND ANY NEW PLAN SHEETS ISSUED BY THE CEC.

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Plans Prepared By:
CPL LLC
A Full Service A & E Firm

STATE OF ARIZONA
LICENSE No. 12007
PROFESSIONAL ENGINEER

Site Location: State of Florida
Professional Engineer: Andrew
The firm has been duly
licensed and registered in the
State of Florida.
License No. 12007


Developed: R. Lewis
Drawn: J. Anderson
Checked: M. Grogan
Job No.: 250101
Date: 04-28
Type of Application:
Major Site Plan

SWPPP PHASE 1

Walmart
WALMART STORES EAST, L.P.

THIS SHEET NOT VALID FOR
CONSTRUCTION WITHOUT
COMPLETE SET OF PLANS

Sheet No.
C13

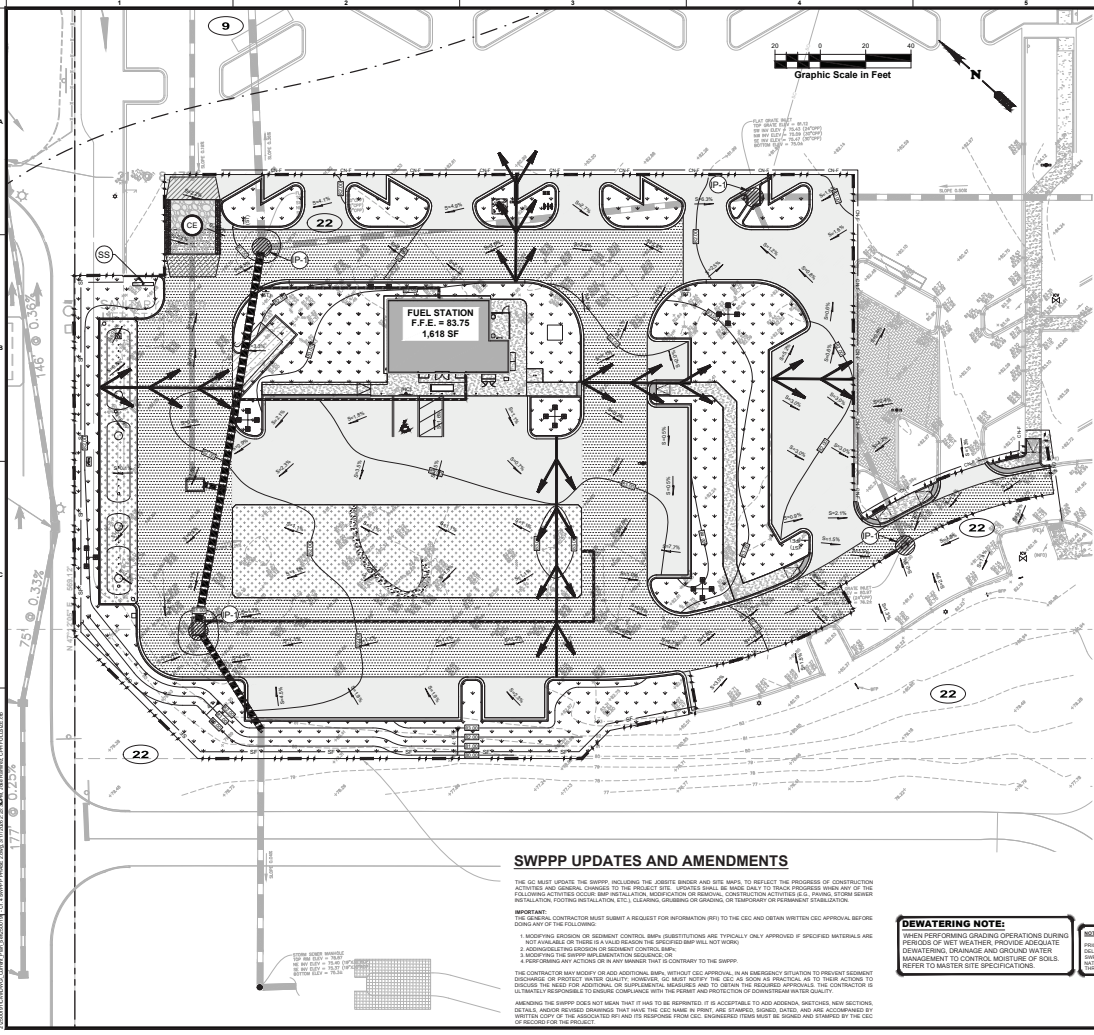

LEGEND

SITE FEATURES:

- PROPERTY LINE
- SOIL BOUNDARY
- LIMITS OF DISTURBANCE
- EXISTING CONTOUR
- EXISTING STORM PIPE
- PROPOSED CONTOUR
- PROPOSED STORM PIPE
- 2.5% SLOPE
- DIRECTION OF OVERLAND FLOW
- LIMITS OF DRAINAGE SUB-BASIN
- EMBARCASS AT ALL ENTRANCE LOCATIONS AND TEMPORARY CONSTRUCTION ACCESS

EROSION NOTES:

- 9 SOIL TYPE: ARIE-CONG SAND, 0 TO 5 PERCENT SILTS
- 22 SOIL TYPE: CANGLES SAND, 0 TO 5 PERCENT SILTS

EROSION DETAILS:

- SP SEDIMENTATION SILT FENCE WITH TIRE TRACKS
- CHP CONSTRUCTION FENCE
- CE TEMPORARY CONSTRUCTION EXIT
- SE SWPPP INFORMATION SIGN
- PF SLEET PROTECTION FILTER SACK

CONTRACTOR NOTE:

WHEN IN CLOSE PROXIMITY, THE LIMITS OF DISTURBANCE SHALL FOLLOW THE BUILDING CURB, FENCE LINES, ETC., UNLESS OTHERWISE INDICATED. LIMITS OF DISTURBANCE SHOWN OUTSIDE BUILDING CURB, FENCE LINES, ETC. FOR CLARITY PURPOSES.

- MINIMIZATION OF DISTURBED AREAS:**
- CONTRACTOR SHALL MANAGE CONSTRUCTION ACTIVITIES TO REDUCE EROSION AND RETAIN SEDIMENT AND OTHER POLLUTANTS IN THE SOIL AT THE CONSTRUCTION SITE.
 - CONTRACTOR SHALL MINIMIZE THE TIME BARE SOIL IS EXPOSED.
 - CONTRACTOR SHALL MINIMIZE SITE DISTURBANCE BY MINIMIZING THE EXTENT OF GRADING AND CLEARING TO EFFECTIVELY REDUCE SEDIMENT YIELD.
- NOTE TO GC: OWNER HAS AUTHORITY AT ANY TIME TO LIMIT SURFACE AREA OF ERODIBLE EARTH MATERIAL EXPOSED BY CLEARING AND GRADING, EXCAVATION, BORROW AND EMBANKMENT OPERATIONS AND TO DIRECT THE GC TO PROVIDE IMMEDIATE PERMANENT OR TEMPORARY POLLUTION CONTROL MEASURES.

NOTE TO GENERAL CONTRACTOR:

PRIOR TO CONSTRUCTION, GC MUST CLEARLY DELINEATE AND MARK OFF AREAS IDENTIFIED IN THE SWPPP OR IN THE FIELDS TO BE PROTECTED (SUCH AS NATURAL BUFFERS, TREES, HABITATS OF ENDANGERED/THREATENED SPECIES, HISTORIC PROPERTIES, ETC.)

SWPPP UPDATES AND AMENDMENTS

THE GC MUST UPDATE THE SWPPP, INCLUDING THE JOBSITE BINDER AND SITE MAPS, TO REFLECT THE PROGRESS OF CONSTRUCTION ACTIVITIES AND/OR CHANGES TO THE PROJECT. SWPPP UPDATES SHALL BE MADE ONLY TO TRACK PROGRESS WHEN ANY OF THE FOLLOWING ACTIVITIES OCCUR: SWPPP RE-EVALUATION, MODIFICATION OR REVISION, CONSTRUCTION ACTIVITIES (E.G. PAVING, STORM SEWER INSTALLATION, EROSION INSTALLATION, ETC.), CLEARING, GRADING OR GRADING, OR TEMPORARY OVERSEEDING/RESTORATION.

IMPORTANT:

- THE GENERAL CONTRACTOR MUST SUBMIT A REQUEST FOR INFORMATION (RFI) TO THE CEC AND OBTAIN WRITTEN CEC APPROVAL BEFORE DURING ANY OF THE FOLLOWING:
- MODIFYING EROSION OR SEDIMENT CONTROL, SWPPP, IDENTIFICATION ARE TRACED ONLY APPROVED AS SPECIFIED MATERIALS ARE NOT AVAILABLE OR THERE IS A VALID REASON THE SPECIFIED SWPPP WILL NOT WORK.
- ADJUSTING EROSION OR SEDIMENT CONTROL MEAS.
- MODIFYING THE SWPPP IMPLEMENTATION SEQUENCE OR A REFORMING ANY ACTIONS OR IN ANY MANNER THAT IS CONTRARY TO THE SWPPP.

THE CONTRACTOR MAY MODIFY OR ADD ADDITIONAL SWPPP WITHOUT CEC APPROVAL IN AN EMERGENCY SITUATION TO PREVENT SEDIMENT DISCHARGE OR PROTECT WATER QUALITY. HOWEVER, GC MUST NOTIFY THE CEC AS SOON AS PRACTICAL AS TO THEIR ACTIONS TO DISCUSS THE NEED FOR ADDITIONAL OR SUPPLEMENTARY MEASURES AND TO OBTAIN THE REQUIRED APPROVAL. THE CONTRACTOR IS SOLELY RESPONSIBLE TO ENSURE COMPLIANCE WITH THE EXISTING AND PROTECTION OF ENVIRONMENTAL WATER QUALITY.

AMENDING THE SWPPP DOES NOT MEAN THAT IT HAS TO BE REPRINTED. IT IS ACCEPTABLE TO ADD ADDITIONAL SHEETS, NEW SECTIONS, DETAILS, AND/OR REVISED DRAWINGS THAT HAVE THE CEC NAME IN PRINT, ARE DATED, SIGNED, DATED, AND ARE ACCOMPANIED BY WRITTEN COPY OF THE AMENDMENT BY AND ITS RESPONSE FROM CEC. ENGINEERED ITEMS MUST BE SIGNED AND STAMPED BY THE CEC OR SECONDARY FOR THE PROJECT.

DEWATERING NOTE:

WHEN PERFORMING GRADING OPERATIONS DURING PERIODS OF WET WEATHER, PROVIDE ADEQUATE CENTERING, SPRAINAGE AND GROUND WATER MANAGEMENT TO CONTROL MOISTURE OF SOILS. REFER TO MASTER SITE SPECIFICATIONS.

SOIL TO AERIAL CONTOUR:

PRIOR TO CONSTRUCTION, GC MUST CLEARLY DELINEATE AND MARK OFF AREAS IDENTIFIED IN THE SWPPP OR IN THE FIELDS TO BE PROTECTED (SUCH AS NATURAL BUFFERS, TREES, HABITATS OF ENDANGERED/THREATENED SPECIES, HISTORIC PROPERTIES, ETC.)

DEVELOPER/OWNER:
 WALMART STORES EAST, L.P.
 MAIL STOP 5570
 2001 SE 10TH STREET
 BENTONVILLE, AR
 72716-5570
 479-204-1195

SITE OPERATOR/GENERAL CONTRACTOR:

SUPERINTENDENT:

IMPORTANT: GC MUST SIGN ALL PLAN SHEETS AND ANY NEW PLAN SHEETS ISSUED BY THE CEC.

cph
 Building Better Communities Together
 www.cphcorp.com
 3811 Warner Street, Suite 103
 Tampa, FL 33609
 Ph: 813.288.8253

Plans Prepared By:
 CPH, LLC
 A Full Service A & E Firm

Professional Engineer
 License No. 125007
 State of Florida
 Professional Engineering

Site Location: Store # 7446
 Professional Engineer
 License No. 125007
 State of Florida
 Professional Engineering

This plan has been digitally signed and certified by the following:
 License No. 125007
 State of Florida
 Professional Engineering

Drawn: J. Anderson
 Checked: M. Grogan
 Job No.: 250191
 Date: 04-28
 Type of Application: Major Site Plan


SWPPP PHASE 2

Walmart
 WALMART STORES EAST, L.P.
 2001 SE 10TH STREET
 BENTONVILLE, AR 72716-5570

THIS SHEET NOT VALID FOR CONSTRUCTION WITHOUT COMPLETE SET OF PLANS


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<p>NOTES:</p> <ol style="list-style-type: none"> 1. SWEEPING OPERATIONS MUST BE PERFORMED FROM THE TOP OF THE WATER COLUMN (I.E., WATER SURFACE) FROM THE END OF THE WATER COLUMN. 2. DO NOT USE SWEEPING WITH PERFORATED PAPER OR ANY OTHER DEBRIS FROM THE WATER COLUMN FRODO THE WATER COLUMN. <p>SKIMMER</p> <p>LAST REVISED: JUNE 2013 WAL-MART STANDARD DETAIL</p>	<p>NOTES:</p> <ol style="list-style-type: none"> 1. VERIFY WITH THE OWNER (PROVIDER) FROM OPERATIONS ACTIVITIES ARE ALLOWED OR ARE NOT ALLOWED AND APPROVED TO OCCUR ON THE WATER COLUMN AND OTHER RELEVANT, AND ALL OPERATIONS MUST BE APPROVED BY THE OWNER (PROVIDER) FROM OPERATIONS ACTIVITIES ARE ALLOWED OR ARE NOT ALLOWED. 2. DO NOT USE SWEEPING WITH PERFORATED PAPER OR ANY OTHER DEBRIS FROM THE WATER COLUMN FRODO THE WATER COLUMN. 3. SWEEPING FROM OPERATIONS MUST BE PERFORMED THROUGH AN APPROVED POLLUTION PREVENTATION PLAN (PPP) WHICH MUST BE APPROVED BY THE OWNER (PROVIDER) FROM OPERATIONS ACTIVITIES ARE ALLOWED OR ARE NOT ALLOWED. 4. SWEEPING FROM OPERATIONS MUST BE PERFORMED THROUGH AN APPROVED POLLUTION PREVENTATION PLAN (PPP) WHICH MUST BE APPROVED BY THE OWNER (PROVIDER) FROM OPERATIONS ACTIVITIES ARE ALLOWED OR ARE NOT ALLOWED. 5. SWEEPING FROM OPERATIONS MUST BE PERFORMED THROUGH AN APPROVED POLLUTION PREVENTATION PLAN (PPP) WHICH MUST BE APPROVED BY THE OWNER (PROVIDER) FROM OPERATIONS ACTIVITIES ARE ALLOWED OR ARE NOT ALLOWED. <p>CHEMICALLY-ENHANCED SETTLING PASSIVE TREATMENT SYSTEMS</p> <p>LAST REVISED: JUNE 2012 WAL-MART STANDARD DETAIL</p>	<p>NOTES:</p> <ol style="list-style-type: none"> 1. VERIFY WITH THE OWNER (PROVIDER) FROM OPERATIONS ACTIVITIES ARE ALLOWED OR ARE NOT ALLOWED AND APPROVED TO OCCUR ON THE WATER COLUMN AND OTHER RELEVANT, AND ALL OPERATIONS MUST BE APPROVED BY THE OWNER (PROVIDER) FROM OPERATIONS ACTIVITIES ARE ALLOWED OR ARE NOT ALLOWED. 2. DO NOT USE SWEEPING WITH PERFORATED PAPER OR ANY OTHER DEBRIS FROM THE WATER COLUMN FRODO THE WATER COLUMN. 3. SWEEPING FROM OPERATIONS MUST BE PERFORMED THROUGH AN APPROVED POLLUTION PREVENTATION PLAN (PPP) WHICH MUST BE APPROVED BY THE OWNER (PROVIDER) FROM OPERATIONS ACTIVITIES ARE ALLOWED OR ARE NOT ALLOWED. 4. SWEEPING FROM OPERATIONS MUST BE PERFORMED THROUGH AN APPROVED POLLUTION PREVENTATION PLAN (PPP) WHICH MUST BE APPROVED BY THE OWNER (PROVIDER) FROM OPERATIONS ACTIVITIES ARE ALLOWED OR ARE NOT ALLOWED. 5. SWEEPING FROM OPERATIONS MUST BE PERFORMED THROUGH AN APPROVED POLLUTION PREVENTATION PLAN (PPP) WHICH MUST BE APPROVED BY THE OWNER (PROVIDER) FROM OPERATIONS ACTIVITIES ARE ALLOWED OR ARE NOT ALLOWED. <p>DEWATERING</p> <p>LAST REVISED: JUNE 2012 WAL-MART STANDARD DETAIL</p>	<p>NOTES:</p> <ol style="list-style-type: none"> 1. VERIFY WITH THE OWNER (PROVIDER) FROM OPERATIONS ACTIVITIES ARE ALLOWED OR ARE NOT ALLOWED AND APPROVED TO OCCUR ON THE WATER COLUMN AND OTHER RELEVANT, AND ALL OPERATIONS MUST BE APPROVED BY THE OWNER (PROVIDER) FROM OPERATIONS ACTIVITIES ARE ALLOWED OR ARE NOT ALLOWED. 2. DO NOT USE SWEEPING WITH PERFORATED PAPER OR ANY OTHER DEBRIS FROM THE WATER COLUMN FRODO THE WATER COLUMN. 3. SWEEPING FROM OPERATIONS MUST BE PERFORMED THROUGH AN APPROVED POLLUTION PREVENTATION PLAN (PPP) WHICH MUST BE APPROVED BY THE OWNER (PROVIDER) FROM OPERATIONS ACTIVITIES ARE ALLOWED OR ARE NOT ALLOWED. 4. SWEEPING FROM OPERATIONS MUST BE PERFORMED THROUGH AN APPROVED POLLUTION PREVENTATION PLAN (PPP) WHICH MUST BE APPROVED BY THE OWNER (PROVIDER) FROM OPERATIONS ACTIVITIES ARE ALLOWED OR ARE NOT ALLOWED. 5. SWEEPING FROM OPERATIONS MUST BE PERFORMED THROUGH AN APPROVED POLLUTION PREVENTATION PLAN (PPP) WHICH MUST BE APPROVED BY THE OWNER (PROVIDER) FROM OPERATIONS ACTIVITIES ARE ALLOWED OR ARE NOT ALLOWED. <p>IRRIGATION OR DISPERSION</p> <p>LAST REVISED: JUNE 2012 WAL-MART STANDARD DETAIL</p>	<p>NOTES:</p> <ol style="list-style-type: none"> 1. VERIFY WITH THE OWNER (PROVIDER) FROM OPERATIONS ACTIVITIES ARE ALLOWED OR ARE NOT ALLOWED AND APPROVED TO OCCUR ON THE WATER COLUMN AND OTHER RELEVANT, AND ALL OPERATIONS MUST BE APPROVED BY THE OWNER (PROVIDER) FROM OPERATIONS ACTIVITIES ARE ALLOWED OR ARE NOT ALLOWED. 2. DO NOT USE SWEEPING WITH PERFORATED PAPER OR ANY OTHER DEBRIS FROM THE WATER COLUMN FRODO THE WATER COLUMN. 3. SWEEPING FROM OPERATIONS MUST BE PERFORMED THROUGH AN APPROVED POLLUTION PREVENTATION PLAN (PPP) WHICH MUST BE APPROVED BY THE OWNER (PROVIDER) FROM OPERATIONS ACTIVITIES ARE ALLOWED OR ARE NOT ALLOWED. 4. SWEEPING FROM OPERATIONS MUST BE PERFORMED THROUGH AN APPROVED POLLUTION PREVENTATION PLAN (PPP) WHICH MUST BE APPROVED BY THE OWNER (PROVIDER) FROM OPERATIONS ACTIVITIES ARE ALLOWED OR ARE NOT ALLOWED. 5. SWEEPING FROM OPERATIONS MUST BE PERFORMED THROUGH AN APPROVED POLLUTION PREVENTATION PLAN (PPP) WHICH MUST BE APPROVED BY THE OWNER (PROVIDER) FROM OPERATIONS ACTIVITIES ARE ALLOWED OR ARE NOT ALLOWED. <p>STOCKPILES</p> <p>LAST REVISED: JUNE 2012 WAL-MART STANDARD DETAIL</p>
<p>NOTES:</p> <ol style="list-style-type: none"> 1. SWEEPING OPERATIONS MUST BE PERFORMED FROM THE TOP OF THE WATER COLUMN (I.E., WATER SURFACE) FROM THE END OF THE WATER COLUMN. 2. DO NOT USE SWEEPING WITH PERFORATED PAPER OR ANY OTHER DEBRIS FROM THE WATER COLUMN FRODO THE WATER COLUMN. <p>SOLID WASTE DISPOSAL</p> <p>LAST REVISED: JUNE 2013 WAL-MART STANDARD DETAIL</p>	<p>NOTES:</p> <ol style="list-style-type: none"> 1. SWEEPING OPERATIONS MUST BE PERFORMED FROM THE TOP OF THE WATER COLUMN (I.E., WATER SURFACE) FROM THE END OF THE WATER COLUMN. 2. DO NOT USE SWEEPING WITH PERFORATED PAPER OR ANY OTHER DEBRIS FROM THE WATER COLUMN FRODO THE WATER COLUMN. <p>MATERIAL LAYOUT AND STORAGE AREA</p> <p>LAST REVISED: JUNE 2013 WAL-MART STANDARD DETAIL</p>	<p>NOTES:</p> <ol style="list-style-type: none"> 1. SWEEPING OPERATIONS MUST BE PERFORMED FROM THE TOP OF THE WATER COLUMN (I.E., WATER SURFACE) FROM THE END OF THE WATER COLUMN. 2. DO NOT USE SWEEPING WITH PERFORATED PAPER OR ANY OTHER DEBRIS FROM THE WATER COLUMN FRODO THE WATER COLUMN. <p>MASON'S AREA</p> <p>LAST REVISED: JUNE 2013 WAL-MART STANDARD DETAIL</p>	<p>NOTES:</p> <ol style="list-style-type: none"> 1. SWEEPING OPERATIONS MUST BE PERFORMED FROM THE TOP OF THE WATER COLUMN (I.E., WATER SURFACE) FROM THE END OF THE WATER COLUMN. 2. DO NOT USE SWEEPING WITH PERFORATED PAPER OR ANY OTHER DEBRIS FROM THE WATER COLUMN FRODO THE WATER COLUMN. <p>HAZARDOUS WASTE DISPOSAL</p> <p>LAST REVISED: JUNE 2013 WAL-MART STANDARD DETAIL</p>	<p>NOTES:</p> <ol style="list-style-type: none"> 1. SWEEPING OPERATIONS MUST BE PERFORMED FROM THE TOP OF THE WATER COLUMN (I.E., WATER SURFACE) FROM THE END OF THE WATER COLUMN. 2. DO NOT USE SWEEPING WITH PERFORATED PAPER OR ANY OTHER DEBRIS FROM THE WATER COLUMN FRODO THE WATER COLUMN. <p>CEMENT AND CONCRETE WASHOUT</p> <p>LAST REVISED: JUNE 2013 WAL-MART STANDARD DETAIL</p>
<p>NOTES:</p> <ol style="list-style-type: none"> 1. SWEEPING OPERATIONS MUST BE PERFORMED FROM THE TOP OF THE WATER COLUMN (I.E., WATER SURFACE) FROM THE END OF THE WATER COLUMN. 2. DO NOT USE SWEEPING WITH PERFORATED PAPER OR ANY OTHER DEBRIS FROM THE WATER COLUMN FRODO THE WATER COLUMN. <p>SANITARY FACILITIES</p> <p>LAST REVISED: JUNE 2013 WAL-MART STANDARD DETAIL</p>	<p>NOTES:</p> <ol style="list-style-type: none"> 1. SWEEPING OPERATIONS MUST BE PERFORMED FROM THE TOP OF THE WATER COLUMN (I.E., WATER SURFACE) FROM THE END OF THE WATER COLUMN. 2. DO NOT USE SWEEPING WITH PERFORATED PAPER OR ANY OTHER DEBRIS FROM THE WATER COLUMN FRODO THE WATER COLUMN. <p>PAINT AND STUCCO WASHOUT</p> <p>LAST REVISED: JUNE 2013 WAL-MART STANDARD DETAIL</p>	<p>NOTES:</p> <ol style="list-style-type: none"> 1. SWEEPING OPERATIONS MUST BE PERFORMED FROM THE TOP OF THE WATER COLUMN (I.E., WATER SURFACE) FROM THE END OF THE WATER COLUMN. 2. DO NOT USE SWEEPING WITH PERFORATED PAPER OR ANY OTHER DEBRIS FROM THE WATER COLUMN FRODO THE WATER COLUMN. <p>FUEL AND PETROLEUM STORAGE AND USE</p> <p>LAST REVISED: JUNE 2013 WAL-MART STANDARD DETAIL</p>	<p>NOTES:</p> <ol style="list-style-type: none"> 1. SWEEPING OPERATIONS MUST BE PERFORMED FROM THE TOP OF THE WATER COLUMN (I.E., WATER SURFACE) FROM THE END OF THE WATER COLUMN. 2. DO NOT USE SWEEPING WITH PERFORATED PAPER OR ANY OTHER DEBRIS FROM THE WATER COLUMN FRODO THE WATER COLUMN. <p>EQUIPMENT AND VEHICLE CLEANING AND MAINTENANCE AREAS</p> <p>LAST REVISED: JUNE 2013 WAL-MART STANDARD DETAIL</p>	<p>NOTES:</p> <ol style="list-style-type: none"> 1. SWEEPING OPERATIONS MUST BE PERFORMED FROM THE TOP OF THE WATER COLUMN (I.E., WATER SURFACE) FROM THE END OF THE WATER COLUMN. 2. DO NOT USE SWEEPING WITH PERFORATED PAPER OR ANY OTHER DEBRIS FROM THE WATER COLUMN FRODO THE WATER COLUMN. <p>TEMPORARY PARKING</p> <p>LAST REVISED: JUNE 2013 WAL-MART STANDARD DETAIL</p>



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
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John L. Lewis, State of Idaho
Professional Engineer - License No. 12007
Civil Engineering
Professional Engineering

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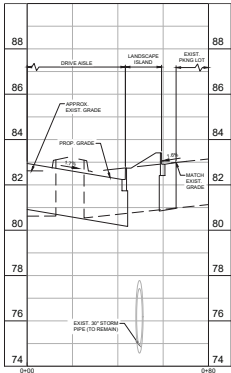
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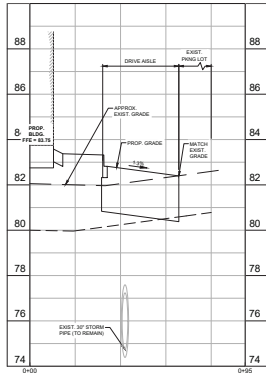
DEVELOPER/OWNER:
WALMART STORES EAST, LP
MAIL STOP 0500
708 8TH STREET
BENTONVILLE, AR 72716-5570
(479) 417-7573
WALMART STORES EAST, LP

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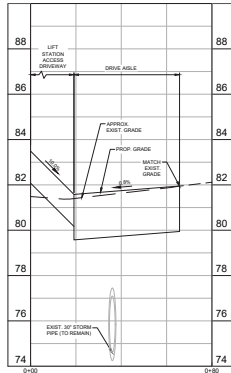
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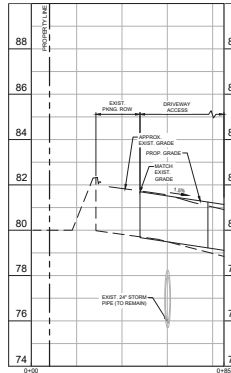
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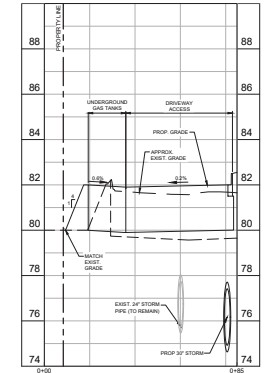
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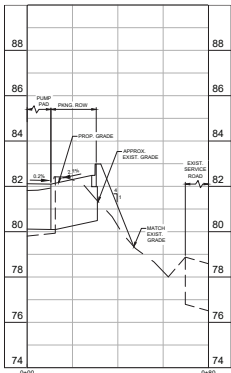
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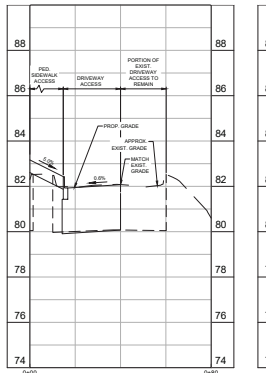
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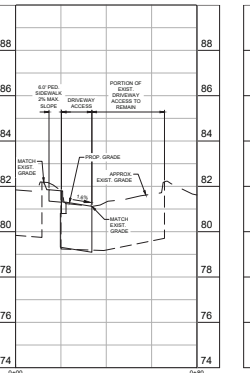
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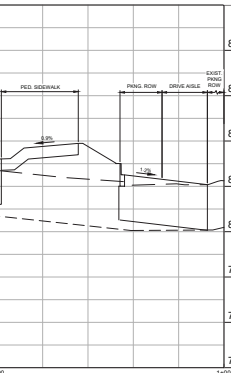
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CROSS SECTION 'H' - 'H'
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1" = 2' VERT



CROSS SECTION 'I' - 'I'
SCALE: 1" = 20' HORIZ
1" = 2' VERT

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Plans Prepared By:
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A Full Service A/E/E Firm

Professional Engineer
STATE OF ARIZONA
LICENSE No. 125007
Professional Engineer
James L. Lemons
This seal has been digitally signed and recorded with the Arizona State Board of Registration for Professional Engineers. License No. 125007 is the user's identification here.

James L. Lemons, State of Arizona
Professional Engineer License No. 125007
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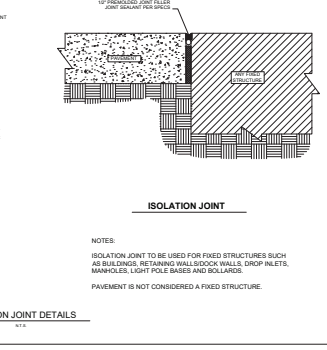
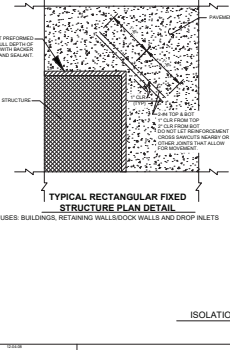
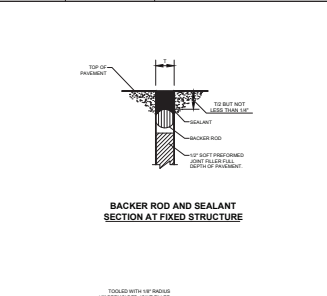
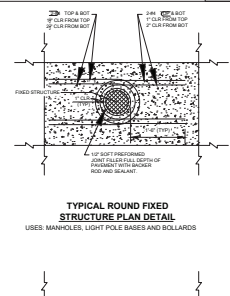
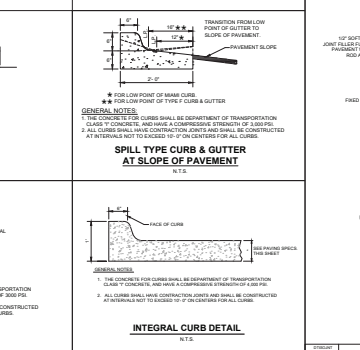
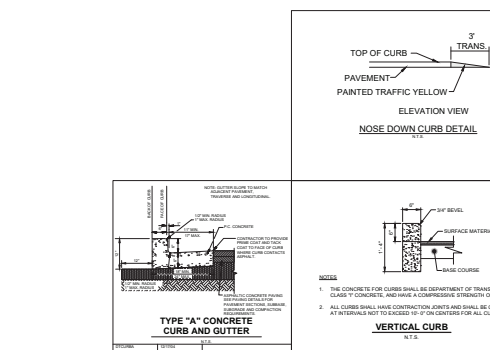
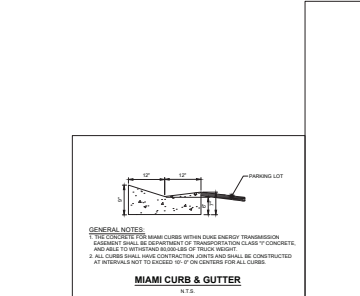
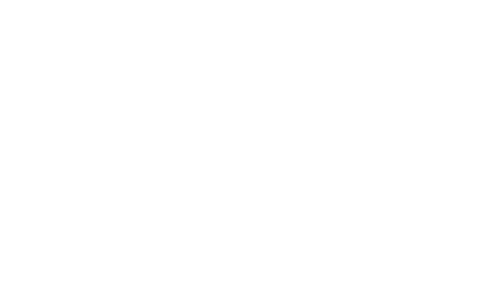
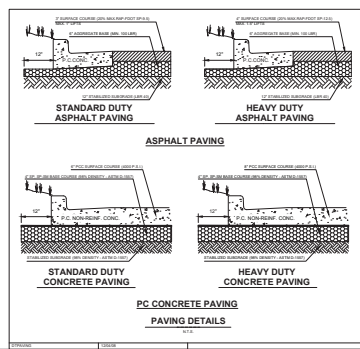
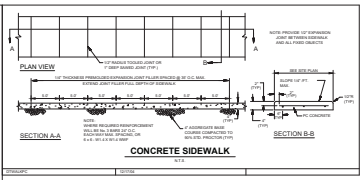
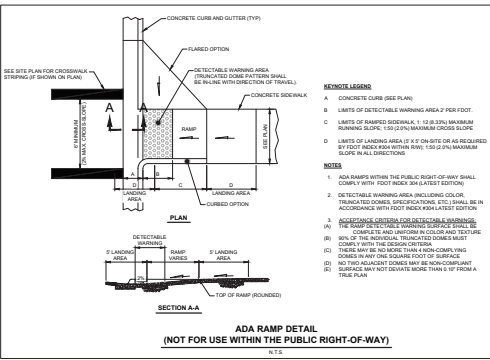
Revised
No. 1
Date: 04/28/2011
By: J. Anderson
Checked: M. Granger
Job No.: 2501011
Date: 04-28-11
Type of Application:
Major Site Plan

SITE CROSS SECTIONS

Walmart
WALMART STORE #1011
11700 N. CENTRAL EXPRESSWAY
SCOTTSDALE, ARIZONA 85258

THIS SHEET NOT VALID FOR CONSTRUCTION WITHOUT COMPLETE SET OF PLANS

Sheet No.
C3.2



- NEWNOTE LEGEND**
- A. CONCRETE CURB (SEE PLAN)
 - B. LIMITS OF DETECTABLE WARNING AREA 2' PER FOOT
 - C. LIMITS OF RAMPED SIDEWALK 1:12 (2%) MAXIMUM RUNNING SLOPE, 1:50 (2%) MAXIMUM CROSS SLOPE
 - D. LIMITS OF LANDING AREA 4' X 4' MINIMUM OR AS REQUIRED BY FOOT ACCESS AREA (MINIMUM 1:50 (2%) MAXIMUM SLOPE IN ALL DIRECTIONS)
- NOTES**
1. ADA RAMP WITHIN THE PUBLIC RIGHT-OF-WAY SHALL COMPLY WITH FOOT ACCESS LATEST EDITION.
 2. DETECTABLE WARNING AREA INCLUDING COLOR, TEXTURE TO COMPLY SPECIFICATIONS SHALL BE IN ACCORDANCE WITH FOOT ACCESS LATEST EDITION.
 3. RAMPING SURFACES SHALL BE FINISHED TO THE SLOPE OF THE DETECTABLE WARNING AREA SHALL BE FINISHED TO THE SLOPE OF THE DETECTABLE WARNING AREA.
 4. (A) SURFACES OF THE RAMPING SURFACES SHALL BE FINISHED TO THE SLOPE OF THE DETECTABLE WARNING AREA SHALL BE FINISHED TO THE SLOPE OF THE DETECTABLE WARNING AREA.
 5. (B) SURFACES OF THE RAMPING SURFACES SHALL BE FINISHED TO THE SLOPE OF THE DETECTABLE WARNING AREA SHALL BE FINISHED TO THE SLOPE OF THE DETECTABLE WARNING AREA.
 6. (C) SURFACES OF THE RAMPING SURFACES SHALL BE FINISHED TO THE SLOPE OF THE DETECTABLE WARNING AREA SHALL BE FINISHED TO THE SLOPE OF THE DETECTABLE WARNING AREA.
 7. (D) SURFACES OF THE RAMPING SURFACES SHALL BE FINISHED TO THE SLOPE OF THE DETECTABLE WARNING AREA SHALL BE FINISHED TO THE SLOPE OF THE DETECTABLE WARNING AREA.

- GENERAL NOTES**
1. THE CONCRETE FOR MIAMI CURBS WITHIN THE SLOPE OF TRANSPORTATION CLASS 'Y' CONCRETE, AND HAVE A COMPRESSIVE STRENGTH OF 3000 PSI.
 2. ALL CURBS SHALL HAVE CONTRACTION JOINTS AND SHALL BE CONSTRUCTED AT INTERVALS NOT TO EXCEED 10'-0" ON CENTERS FOR ALL CURBS.

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1. THE CONCRETE FOR CURBS SHALL BE DEPARTMENT OF TRANSPORTATION CLASS 'Y' CONCRETE, AND HAVE A COMPRESSIVE STRENGTH OF 3000 PSI.
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3801 Warner Street, Suite 103
Tampa, FL 33606
PH: 813.286.8223

Plans Prepared By:
CPL LLC
A Full Service A & E Firm

STATE OF
FLORIDA
PROFESSIONAL ENGINEER
No. 12007
Date of Issue: 01/15/2017

Drawn: J. Anderson
Checked: M. Granger
Job No.: 250101
Date: 01-26-17
Type of Application: Major Site Plan

REVISIONS

NO. DATE BY









DESIGNED: R. Lemons
DRAWN: J. Anderson
CHECKED: M. Granger
JOB NO.: 250101
DATE: 01-26-17
TYPE OF APPLICATION: Major Site Plan

MISCELLANEOUS DETAILS

Walmart
WALMART STORES, INC.
191 N. MILITARY AVE., SUITE 100
CORAL GABLES, FLORIDA 33134

THIS SHEET NOT VALID FOR CONSTRUCTION WITHOUT COMPLETE SET OF PLANS

Sheet No.
C5.2

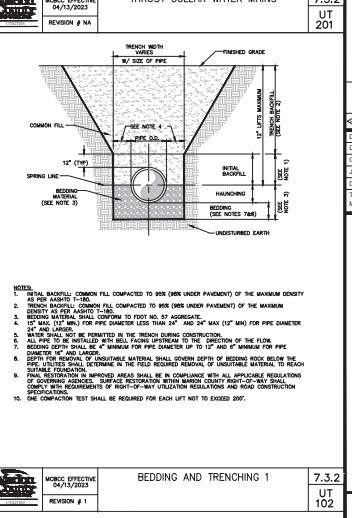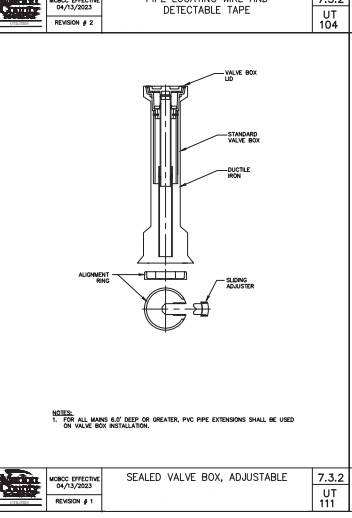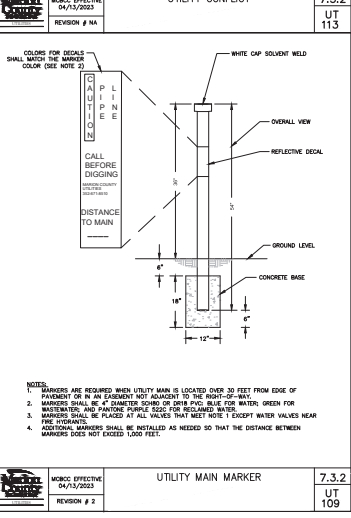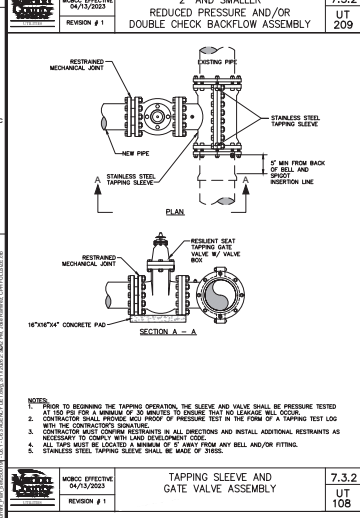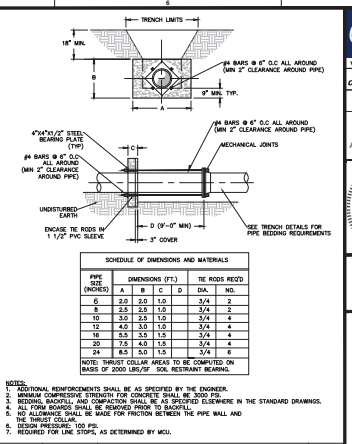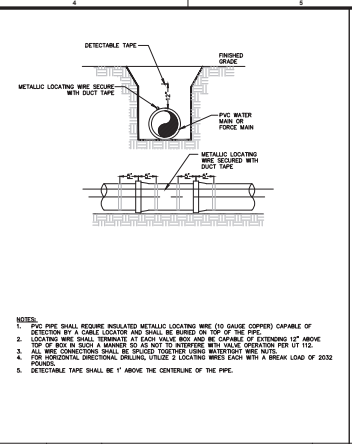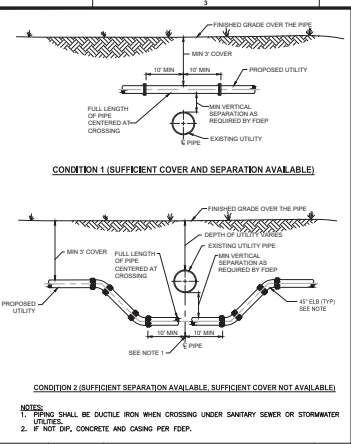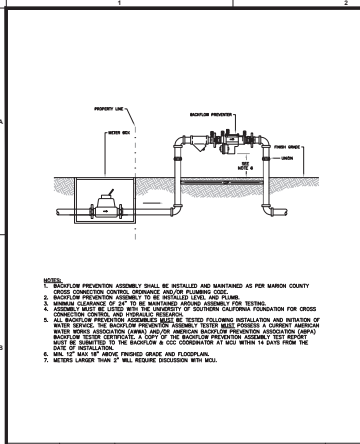

cph
www.cphcorp.com
Building Better Communities Together

Plans Prepared By:
CPL LLC
A Full Service A/E Firm

STATE OF ILLINOIS
PROFESSIONAL ENGINEERING
LICENSE NO. 120007
JAMES R. LEMMONS
Professional Engineer

Designated: R. Lemmons
Drawn: J. Anderson
Checked: M. Grogan
Job No.: 2020191
Date: 04-28-20
Type of Application: Major Site Plan

walmart
AGENCY DETAILS SHEET
THIS SHEET NOT VALID FOR CONSTRUCTION WITHOUT COMPLETE SET OF PLANS
Sheet No. **C6.1**

EVOLVE
EALS Series
LED Outdoor Area Light

CUSTOMER NAME: _____
PROJECT NAME: _____ TYPE: _____
DATE: _____
CATALOG NUMBER: _____

The EALS Area Light family offers a wide range of optical patterns, color temperatures, lumen packages and mounting configurations to ensure area light applications, as well as provide versatility in lighting design within the same form factor. They are ideal commercial property site lighting applications such as retail and commercial exterior.

Construction
Housing: Aluminum die cast extrusion
Lumens: Integral heat sink for maximum heat transfer
Lens: Impact resistant polycarbonate
Paint: Corrosion resistant polyester powder paint, minimum 20 mil thickness
Weight: 27 lbs

Lumen Maintenance
Lumen Depreciation: 30% @ 50,000 hours
Lumen Output: 100% @ 0 hours

Optical System
Lumens: 2000 - 20,000
Prevalence: 30° to 15° Beam
Efficacy: 100-150 LM/W
CRI: 90-95
CCT: 2700K-6500K
DALI: 2-10
0-10V

Upward Light Output Ratio (ULOR): 0% Horizontal Orientation

Electrical
Input Voltage: 120-277V, 277-480V & 240-480V
Input Frequency: 50/60 Hz
Power Factor (PF): > 0.95 at all load levels
Total Harmonic Distortion (THD): < 15%
Surge Protection: 1000V Surge Protection

Operating Temperature: -40°C to 40°C
Operating Humidity: 5% to 95% RH
Operating Voltage: 120-277V, 277-480V & 240-480V

Controls
Dimming: 0-10V, DALI, 0-10V, 0-10V, 0-10V
Sensors: Photo Sensors, Sensors (PI) available
Lighting and Detection Capabilities

Warranty
5 Year (Standard) / 10 Year (Optional)

Current LED Lumens Page 4 of 4
www.currentled.com

EVOLVE
EALS Series
LED Outdoor Area Light

CUSTOMER NAME: _____
PROJECT NAME: _____ TYPE: _____
DATE: _____
CATALOG NUMBER: _____

Ordering Information

EALS 03 7

Product #	Dimensions	Weight	Optical	Temperature	Color	Beam	Power	Efficiency	UL	Notes
AS-03-001	27" x 14" x 14"	27 lbs	1000-2000	2700K-6500K	0-10V	30°	100-150 LM/W	> 90	UL Type: E	Standard
AS-03-002	27" x 14" x 14"	27 lbs	2000-4000	2700K-6500K	0-10V	30°	100-150 LM/W	> 90	UL Type: E	Standard
AS-03-003	27" x 14" x 14"	27 lbs	4000-8000	2700K-6500K	0-10V	30°	100-150 LM/W	> 90	UL Type: E	Standard
AS-03-004	27" x 14" x 14"	27 lbs	8000-16000	2700K-6500K	0-10V	30°	100-150 LM/W	> 90	UL Type: E	Standard
AS-03-005	27" x 14" x 14"	27 lbs	16000-32000	2700K-6500K	0-10V	30°	100-150 LM/W	> 90	UL Type: E	Standard

Current LED Lumens Page 4 of 4
www.currentled.com

EVOLVE
EALS Series
LED Outdoor Area Light

CUSTOMER NAME: _____
PROJECT NAME: _____ TYPE: _____
DATE: _____
CATALOG NUMBER: _____

Non-Standard Sizing Option

For additional information on Non-Standard Sizing EALS Res, please refer to E2000

Product #	Dimensions	Weight	Optical	Temperature	Color	Beam	Power	Efficiency	UL	Notes
AS-03-006	27" x 14" x 14"	27 lbs	1000-2000	2700K-6500K	0-10V	30°	100-150 LM/W	> 90	UL Type: E	Standard
AS-03-007	27" x 14" x 14"	27 lbs	2000-4000	2700K-6500K	0-10V	30°	100-150 LM/W	> 90	UL Type: E	Standard
AS-03-008	27" x 14" x 14"	27 lbs	4000-8000	2700K-6500K	0-10V	30°	100-150 LM/W	> 90	UL Type: E	Standard
AS-03-009	27" x 14" x 14"	27 lbs	8000-16000	2700K-6500K	0-10V	30°	100-150 LM/W	> 90	UL Type: E	Standard
AS-03-010	27" x 14" x 14"	27 lbs	16000-32000	2700K-6500K	0-10V	30°	100-150 LM/W	> 90	UL Type: E	Standard

Current LED Lumens Page 4 of 4
www.currentled.com

EVOLVE
EALS Series
LED Outdoor Area Light

CUSTOMER NAME: _____
PROJECT NAME: _____ TYPE: _____
DATE: _____
CATALOG NUMBER: _____

Asymmetric Beam Angle Beam Patterns

AS-03-011, AS-03-012, AS-03-013, AS-03-101, 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