

February 28, 2024

PROJECT NAME: HEAGY BURRY BOAT RAMP IMPROVEMENTS

PROJECT NUMBER: 2014030034

APPLICATION: MAJOR SITE PLAN REVISION #30905

- 1 DEPARTMENT: ENGIN - DEVELOPMENT REVIEW
REVIEW ITEM: 2.12.4.K - List of approved waivers, their conditions, and the date of approval
STATUS OF REVIEW: INFO
REMARKS: 1/16/24 - add waivers if requested in the future
- 2 DEPARTMENT: ENGIN - DEVELOPMENT REVIEW
REVIEW ITEM: 2.21.2.A - Multi-phase Major Site Plans may include a separate sheet showing independent, stand alone phasing and shall not be subject to a separate Master Plan application
STATUS OF REVIEW: INFO
REMARKS: 2/16/24-phasing remains unchanged from the previously approved plans - sk
1/16/24 - no phasing shown
- 3 DEPARTMENT: ENGIN - DEVELOPMENT REVIEW
REVIEW ITEM: Additional Development Review Comments
STATUS OF REVIEW: INFO
REMARKS: After approval, plans will be electronically stamped by the County. The applicant will receive an email indicating that approved plans are available for download and are located in the ePlans project Approved folder. For Development Review submittals, with the exception of Final Plats and Minor Site Plans, applicants are required to print, obtain required signatures, and sign and seal two 24"x 36" sets of the electronically stamped approved plan and deliver them to the Office of County Engineer, Development Review Section, located at 412 SE 25th Avenue Ocala, FL 34471. Upon receipt, a development order will be issued. Until such time as that development order is issued, the project does not have final approval and construction, if applicable, shall not commence. For plans requiring As-Builts, As-Builts and associated documentation shall be submitted on paper in accordance with current county requirements.
- 4 DEPARTMENT: UTIL - MARION COUNTY UTILITIES
REVIEW ITEM: Additional Utilities comments
STATUS OF REVIEW: INFO
REMARKS: (1) Unable to review previous approved plan AR 13066; it was signed off with 'no central water or sewer available' prior to current staff in this position, but confirmed there is no public sewer manhole available for connection. Defer to DOH for wastewater compliance.
(2) changemarks on site plan but do not affect utility sign-off/for information only.
- 5 DEPARTMENT: DOH - ENVIRONMENTAL HEALTH
REVIEW ITEM: DEP Water Approval
STATUS OF REVIEW: INFO
REMARKS: Well will supply restrooms. Apply for well permit through the Department of Health in Marion County
- 6 DEPARTMENT: DOH - ENVIRONMENTAL HEALTH
REVIEW ITEM: Additional Health comments
STATUS OF REVIEW: INFO
REMARKS: OSTDS systems must be at least 75' from all surface water high level lines.
Protect existing well during all phases of demolition and construction.
OSTDS permit will be required and fees paid.

- 7 DEPARTMENT: LUCURR - LAND USE CURRENT REVIEW
REVIEW ITEM: Additional Planning Items:
STATUS OF REVIEW: INFO
REMARKS: This revision is solely for connection to septic and drainfield instead of connection to sewer- no other changes made from initial major site plan approval.
- 8 DEPARTMENT: LSCAPE - LANDSCAPE DESIGN AND IRRIGATION
REVIEW ITEM: Additional Landscape comments
STATUS OF REVIEW: INFO
REMARKS: Landscape plan previously approved AR#13066 - no changes to landscape plan with this submittal.
- 9 DEPARTMENT: ENRAA - ACQ AGENT ENG ROW
REVIEW ITEM: Major Site Plan
STATUS OF REVIEW: INFO
REMARKS: IF APPLICABLE:
Sec. 2.18.1.I - Show connections to other phases.
Sec.2.19.2.H – Legal Documents
Legal documents such as Declaration of Covenants and Restrictions, By-Laws, Articles of Incorporation, ordinances, resolutions, etc.
Sec. 6.3.1.B.1 – Required Right of Way Dedication (select as appropriate)
For Public Streets. "[All streets and rights-of-way shown on this plat or name specifically if less than all] are hereby dedicated for the use and benefit of the public."
Sec. 6.3.1.B.2 – Required Right of Way Dedication
For Non-Public Streets. "[All streets and rights-of-way shown on this plat or name specifically if less than all] are hereby dedicated privately to the [entity name]. All public authorities and their personnel providing services to the subdivision are granted an easement for access. The Board of County Commissioners of Marion County, Florida, shall have no responsibility, duty, or liability whatsoever regarding such streets. Marion County is granted an easement for emergency maintenance in the event of a local, state, or federal state of emergency wherein the declaration includes this subdivision or an emergency wherein the health, safety, or welfare of the public is deemed to be at risk."
Sec. 6.3.1.D.3 - Cross Access Easements
For Cross Access Easements. "All parallel access easements shown on this plat are hereby dedicated for the use and benefit of the public, and maintenance of said easements is the responsibility of [entity name]."
Sec. 6.3.1.C.1 - Utility Easements (select as appropriate)
"[All utility easements shown or noted or name specifically if less than all] are dedicated [private or to the public] for the construction, installation, maintenance, and operation of utilities by any utility provider."
Sec. 6.3.1.C.2 – Utility Easements
"[All utility tracts or identify each tract as appropriate] as shown are dedicated [private or to the public] for the construction and maintenance of such facilities."
Sec.6.3.1.D(c)(1)(2)(3) - Stormwater easements and facilities, select as appropriate:
1. "[All stormwater and drainage easements as shown or noted or name specifically if less than all] are dedicated [private or to the public] for the construction and maintenance of such facilities."
2. "[All stormwater management tracts or identify each tract as appropriate] as shown are dedicated [private or to the public] for the construction and maintenance of such facilities."
3. When any stormwater easement and/or management tract is not dedicated to the public or Marion County directly, the following statement shall be added to the dedication language: "Marion County is granted the right to perform emergency maintenance on the [stormwater easement and/or management tract, complete accordingly] in the event of a local, state, or federal state of emergency wherein the declaration includes this subdivision or an emergency wherein the health, safety, or welfare of the public is deemed to be at risk."
Sec.6.3.1.D(f) –
If a Conservation Easement is required the following shall be provided: "A conservation easement [as shown

or on tract and identify the tract, complete accordingly] is dedicated to [the Board of County Commissioners of Marion County, Florida or entity name, if not Marion County] for the purpose of preservation of [listed species, habitat, Karst feature and/or native vegetation, complete accordingly]."



Marion County Board of County Commissioners

Office of the County Engineer

412 SE 25th Ave.
Ocala, FL 34471
Phone: 352-671-8686
Fax: 352-671-8687

DEVELOPMENT REVIEW PLAN APPLICATION

Date: November 29, 2023

A. PROJECT INFORMATION:

Project Name: HEAGY BURRY BOAT RAMP IMPROVEMENTS

Parcel Number(s): 02786-005-00; 02789-001-00

Section ²¹ Township ¹² Range ²¹ Land Use RURAL LANDS/PUBLIC Zoning Classification G-U

Commercial ☐ Residential ☒ Industrial ☐ Institutional ☐ Mixed Use ☒ Other PUBLIC USE

Type of Plan: MAJOR SITE PLAN

Property Acreage ^{4.53} Number of Lots Miles of Roads

Location of Property with Crossroads On NW 191 Place, approx. 0.65 miles east of US-441

Additional information regarding this submittal: This is a amendment to the previously approved plans under Marion County AR Number: 13066.

The revisions generally consist of connecting the sanitary sewer system to a proposed a septic tank & drain field in lieu of connecting to an existing public sanitary MH.

B. CONTACT INFORMATION *(Check the appropriate box indicating the point for contact for this project. Add all emails to receive correspondence during this plan review.)*



Engineer:

Firm Name: Kimley-Horn & Associates, Inc. Contact Name: Richard V. Busche

Mailing Address: 1700 SE 17th Street, Suite 200 City: Ocala State: FL Zip Code: 34471

Phone # 352-438-3000 Alternate Phone #

Email(s) for contact via ePlans: ocala.permits@kimley-horn.com



Surveyor:

Firm Name: Contact Name:

Mailing Address: City: State: Zip Code:

Phone # Alternate Phone #

Email(s) for contact via ePlans:

Property Owner:

Owner: Marion County Board of County Commissioners Contact Name:

Mailing Address: 601 SE 25th Avenue City: Ocala State: FL Zip Code: 34471

Phone # 352-671-8560 Alternate Phone #

Email address: joeey.amodo@marionfl.org

Developer:

Developer: Contact Name:

Mailing Address: City: State: Zip Code:

Phone # Alternate Phone #

Email address:

Revised 6/2021



Marion
County
FLORIDA
PARKS AND RECREATION

HEAGY BURRY BOAT RAMP IMPROVEMENTS, PHASE 1 AND 2 MAJOR SITE PLAN

FOR MARION COUNTY BOARD OF COUNTY COMMISSIONERS

MARION COUNTY, FLORIDA SECTION 21, TOWNSHIP 12 SOUTH, RANGE 21 EAST

GENERAL NOTES

LAND USE DEVELOPMENT DATA

PARKS, RECREATION NUMBER: 02786-005-00, 02908-001-00.

PRESENT ZONING: O-U

ABUTTING ZONING: NORTH - B-2
EAST - B-2
SOUTH - B-4
WEST - B-2/R-4

LAND USE: RURAL LANDS/PUBLIC

AREA DESCRIPTION	PHASE 1	PHASE 2	TOTALS
PROPOSED SITE AREA	2.86	1.67	4.53
PROPOSED IMPERVIOUS AREA	1.35	0.67	2.22
PROPOSED PERVIOUS AREA	1.51	0.80	2.31
PROJECT AREA IN FLOODPLAIN	0.10	0.00	0.10

WATER: POTABLE WATER WILL BE PROVIDED BY AN EXISTING WELL.

SEWER: WASTEWATER FACILITIES WILL BE BY ON-SITE SEWAGE TREATMENT AND DISPOSAL SYSTEMS (0.12-0.5) AND WILL BE MAINTAINED BY THE MARION COUNTY PARKS AND RECREATION DEPARTMENT.

GARBAGE: SOLID WASTE PICKUP WILL BE PROVIDED BY MARION COUNTY.

OWNERSHIP AND MAINTENANCE: THE PROJECT AREA AND ALL IMPROVEMENTS ARE OWNED BY THE MARION COUNTY BOARD OF COUNTY COMMISSIONERS. ALL IMPROVEMENTS AND COMMON AREAS WILL BE MAINTAINED AND MANAGED BY THE MARION COUNTY PARKS AND RECREATION DEPARTMENT.

EASEMENTS: ALL EASEMENTS ARE DESIGNATED ON THE PLANS.

FEMA DESIGNATION: THE PROJECT AREA LIES IN FLOOD HAZARD ZONE AC WITH A BASE FLOOD ELEVATION OF 60.4', FLOOD HAZARD ZONE AL WITH A BASE FLOOD ELEVATION OF 61' AND IN ZONE "Y", AN AREA OF 0.2% ANNUAL CHANCE OF FLOOD ACCORDING TO THE FEDERAL EMERGENCY MANAGEMENT AGENCY FLOOD INSURANCE RATE MAP, COMMUNITY-PANEL NUMBERS 12001C00150 AND 12083C01400, EFFECTIVE DATE AUGUST 28, 2008.

MARION COUNTY SPILLS PROTECTION ZONE: SECONDARY ZONE

ENVIRONMENTALLY SENSITIVE, SHORELINE ZONE: ORANGE LAKE (SHORELINE ONLY)

DRAINAGE: THE DRAINAGE SYSTEM WILL BE MAINTAINED BY MARION COUNTY.

LOCAL BENCHMARK: VERTICAL DATUM IS BASED ON NAD 83, PROJECTED FROM BENCHMARK BM-1459-15, MARION COUNTY VERTICAL CONTROL STATION, ELEV. 58.945 FEET.

STATE PLANE COORDINATE: THE BASIS OF BEARING IS AN ASSUMED BEARING OF S89°44'00"E, BETWEEN FOUND MONUMENTATION ALONG THE SOUTH LINE OF SECTION 21, TOWNSHIP 12 SOUTH, RANGE 21 EAST.

ADDITIONAL NOTES

- TOPOGRAPHIC INFORMATION PROVIDED BY: GEORGE F. YOUNG, INC. AND GPI SOUTHEAST, INC.
- TOPOGRAPHY SHALL BE VERIFIED PRIOR TO CONSTRUCTION.
- A PERMIT MUST BE OBTAINED FROM MARION COUNTY ENGINEERING DEPARTMENT (RIGHT-OF-WAY DIVISION) PRIOR TO COMMENCEMENT OF ANY WORK IN THE COUNTY RIGHT-OF-WAY.
- THIS PROJECT HAS NOT BEEN GRANTED CONCURRENCY APPROVAL AND/OR GRANTED AND/OR RESERVED ANY PUBLIC FACILITY CAPACITIES. FUTURE RIGHTS TO DEVELOP THE RESULTING PROPERTY(IES) ARE SUBJECT TO A DETERMINED CONCURRENCY DETERMINATION AND FINAL APPROVAL TO DEVELOP THE PROPERTY HAS NOT BEEN OBTAINED. THE COMPLETION OF CONCURRENCY REVIEW AND/OR APPROVAL HAS BEEN DEFERRED TO LATER DEVELOPMENT REVIEW STAGES, SUCH AS, BUT NOT LIMITED TO, MASTER PLAN, SUBDIVISION PLAN, SITE PLAN, AND/OR BUILDING PERMIT REVIEW.

PROJECT OWNER AND CONSULTANTS

OWNER/APPLICANT:
MARION COUNTY BOARD OF
COUNTY COMMISSIONERS
601 SE 25TH AVENUE
OCALA, FLORIDA 34471

CIVIL ENGINEERING CONSULTANT:
KIMLEY-HORN AND ASSOCIATES, INC.
1700 SE 17TH STREET, SUITE 200
OCALA, FLORIDA 34471
(352) 438-3000

DUKE ENERGY
4350 SE MARICAMP ROAD
OCALA, FLORIDA 34480
(352) 239-0970

SURVEYOR:
GEORGE F. YOUNG, INC.
1905 SOUTH MAIN STREET
GAINESVILLE, FLORIDA 32601
(352) 378-1444

SURVEYOR:
GPI SOUTHEAST, INC.
1414 SW MILK JR. AVE
OCALA, FL 34474
(352) 368-5055

GEOTECHNICAL ENGINEER:
UNIVERSAL ENGINEERING SCIENCES, INC.
4475 SW 35TH TERRACE
GAINESVILLE, FLORIDA 32608
(352) 372-3392



APPROVED MARION COUNTY WAIVERS

1.	04/21/2014	6.13.7.8 (3)	GEOTECHNICAL CRITERIA (DRA-01A, DRA-01B)
2.	04/21/2014	6.13.3.3 (2)	STORMWATER FACILITY CRITERIA (DRA-01A, DRA-01B)
3.	04/21/2014	6.13.5.0	FLOOD PLAN MAP AMENDMENT
4.	04/21/2014	6.8.6	BUFFERING
5.	06/02/2014	6.10.7	KARST FEATURE CONSERVATION

I HEREBY CERTIFY THAT I, MY SUCCESSORS AND ASSIGNS SHALL PERPETUALLY OPERATE AND MAINTAIN THE STORMWATER MANAGEMENT SYSTEM AND ASSOCIATED ELEMENTS IN ACCORDANCE WITH THE SPECIFICATIONS SHOWN HEREIN AND ON THE APPROVED PLANS.

JAMES COULLARD, DIRECTOR
MARION COUNTY PARKS AND RECREATION DEPARTMENT

I HEREBY CERTIFY THAT THESE PLANS WERE COMPLETED IN ACCORDANCE WITH ALL APPLICABLE REQUIREMENTS OF THE MARION COUNTY LAND DEVELOPMENT CODE, EXCEPT AS WAIVED.

LICENSE PROFESSIONAL

RICHARD V. BUSCH, P.E.
DECEMBER 2023
FLORIDA LICENSE NUMBER
555568

DRAWING INDEX

- 01 COVER SHEET
- 02 GENERAL NOTES
- 03 DEMOLITION PLAN
- 04 MASTER SITE PLAN
- 05 SITE PLAN
- 06 SIGNING AND MARKING PLAN
- 07 SIGNING AND MARKING PLAN
- 08 PAVING, GRADING AND DRAINAGE PLAN
- 09 PAVING, GRADING AND DRAINAGE PLAN
- 10 CONSTRUCTION DETAILS
- 11 CONSTRUCTION DETAILS
- 12 CONSTRUCTION DETAILS
- 13 POND DETAILS
- 14 BOAT RAMP DETAILS
- 15 EROSION CONTROL PLAN
- 16 EROSION CONTROL NOTES
- 17 EROSION CONTROL DETAILS
- 18 ENVIRONMENTAL IMPACTS
- L1.01 TREE PROTECTION PLAN
- L1.02 TREE PROTECTION PLAN
- L2.01 LANDSCAPE PLAN
- L2.02 LANDSCAPE PLAN
- L3.01 PLANTING DETAILS
- S-01 SURVEY
- S-02 SURVEY
- S-03 SURVEY
- S-04 SURVEY
- S-01 HYDROGRAPHIC SURVEY
- S-01 HYDROGRAPHIC SURVEY

PROJECT TRAFFIC STATEMENT:
THE PROPOSED MODIFICATIONS TO THE HEAGY BURRY BOAT RAMP PARK INCLUDE IMPROVEMENTS TO THE PARK'S PARKING LOT LAYOUT AND INTERNAL TRAFFIC CIRCULATION. NO ADDITIONAL BOAT RAMPS ARE BEING PROPOSED. THE PROJECT'S APPLICABLE LAND USE CODE WITHIN THE INSTITUTE OF TRANSPORTATION ENGINEERS' (ITE) TRIP GENERATION MANUAL, 9TH EDITION, IS THE 412 - COUNTY PARK, WHICH BASES TRIP GENERATION CHARACTERISTICS ON A PARK'S ACREAGE. THE PARK'S ACREAGE IS NOT CHANGING, THEREFORE ITS TRIP GENERATION CHARACTERISTICS SHOULD NOT CHANGE AS A RESULT OF THIS PROJECT.



COVER SHEET

HEAGY BURRY BOAT RAMP
PREPARED FOR
MARION COUNTY BOARD OF
COUNTY COMMISSIONERS
MARION COUNTY
FLORIDA

SHEET NUMBER
01

HEAGY BURRY BOAT RAMP - MARION COUNTY MAJOR SITE PLAN

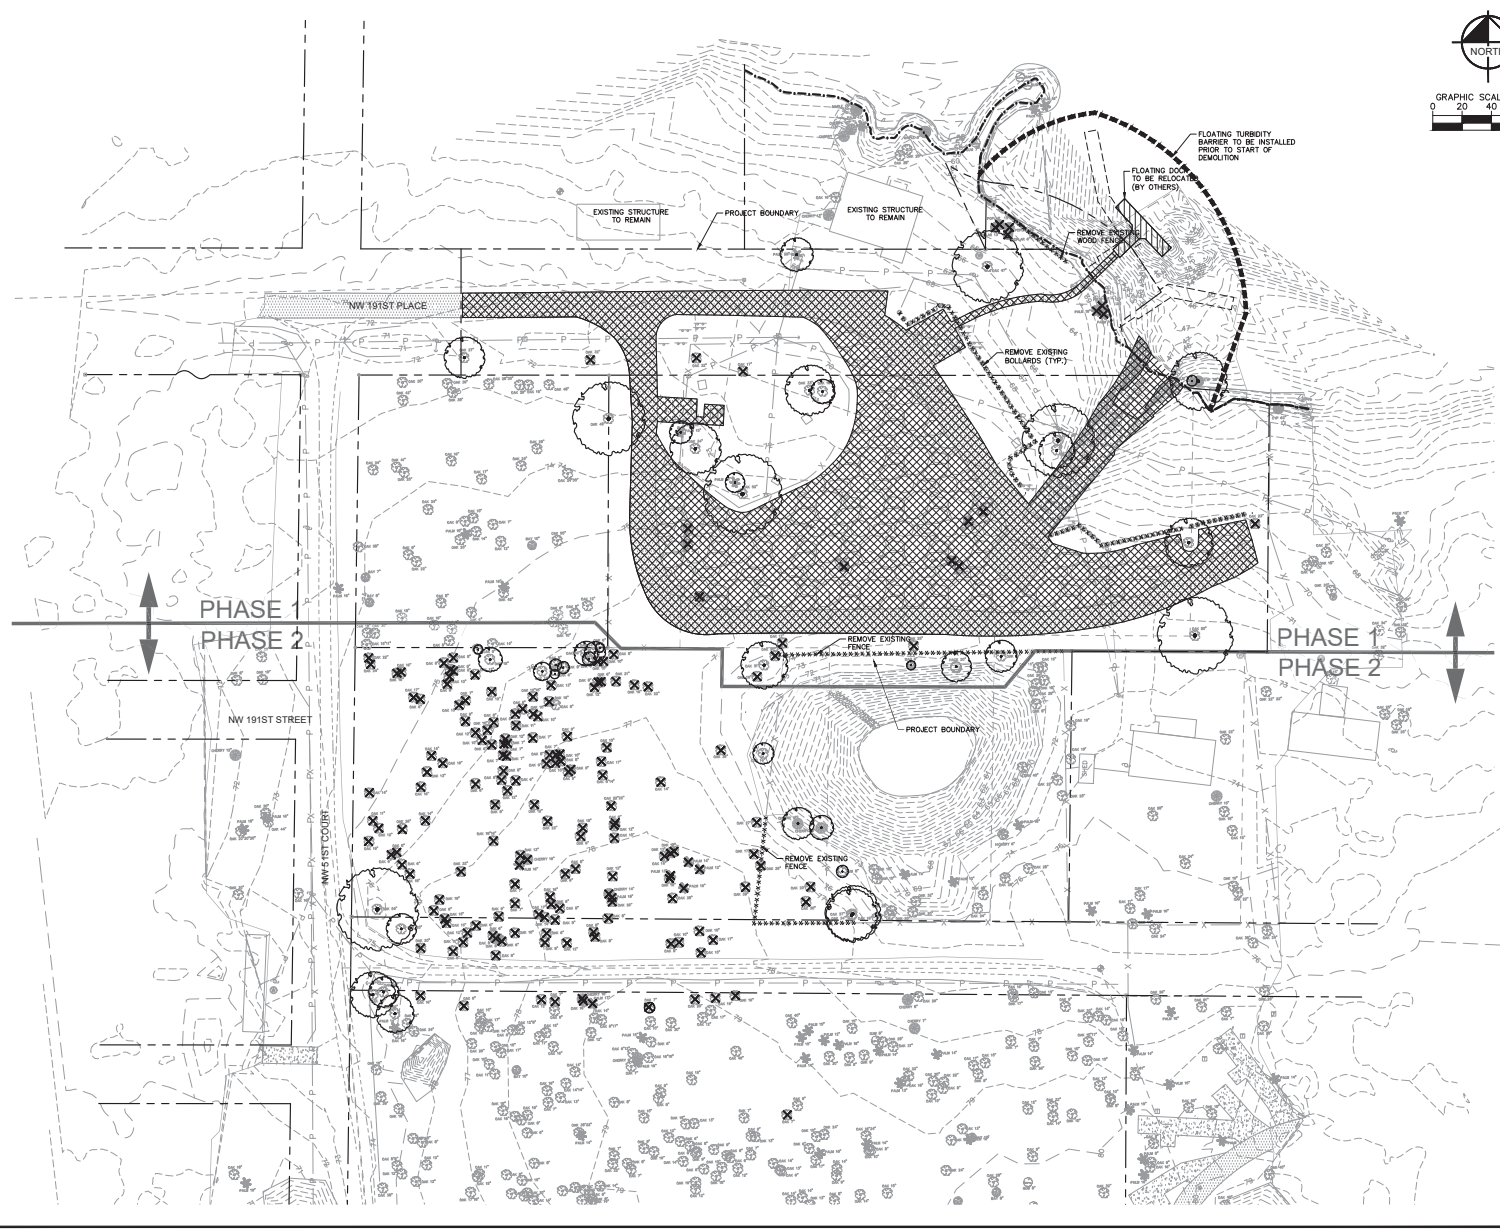
Kimley-Horn

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OCALA, FLORIDA 34471
PHONE (352) 438-3000
WWW.KIMLEY-HORN.COM REBERTY NO. 20108

REVISIONS

DATE BY

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LEGEND

IMPROVEMENTS TO BE REMOVED

TREES TO BE PRESERVED WITH TREE PROTECTION ZONE. BARRICADES PER MARION COUNTY LAND DEVELOPMENT CODE

TREES TO BE REMOVED


DEMOLITION NOTES

1. ALL MATERIAL REMOVED FROM THIS SITE BY THE CONTRACTOR SHALL BE DISPOSED OF BY THE CONTRACTOR IN A LEGAL MANNER.

2. REFER TO THE TOPOGRAPHIC SURVEY FOR ADDITIONAL DETAILS OF EXISTING STRUCTURES, ETC. LOCATED WITHIN THE PROJECT SITE. UNLESS OTHERWISE NOTED, ALL EXISTING BUILDINGS, STRUCTURES, SLABS, CONCRETE, ASPHALT, GROUND PILES, SIGNS AND ALL APPURTENANCES ARE TO BE REMOVED FROM THE SITE BY THE CONTRACTOR AND PROPERLY DISPOSED OF IN A LEGAL MANNER AS PART OF THIS CONTRACT. SOME ITEMS TO BE REMOVED MAY NOT BE DETECTED ON THE TOPOGRAPHIC SURVEY. IT IS THE CONTRACTOR'S RESPONSIBILITY TO VISIT THE SITE AND DETERMINE THE FULL EXTENT OF ITEMS TO BE REMOVED. IF ANY ITEMS ARE IN QUESTION, THE CONTRACTOR SHALL CONTACT THE OWNER PRIOR TO REMOVAL OF SAID ITEMS.

3. THE CONTRACTOR SHALL REFER TO THE DEMOLITION PLAN FOR DEMOLITION AND/OR PRESERVATION OF EXISTING TREES AND NATURAL AREAS. ALL TREES NOT SPECIFICALLY SHOWN TO BE PRESERVED OR RELOCATED SHALL BE REMOVED AS PART OF THIS CONTRACT IF THEY CONFLICT WITH THE CONSTRUCTION OF ANY OF THE PROPOSED IMPROVEMENTS. TREE PROTECTION BARRICADES AND FENCING SHALL BE INSTALLED AND MONITORED IN ACCORDANCE WITH THE LOCAL JURISDICTIONAL REQUIREMENTS PRIOR TO ANY DEMOLITION ACTIVITIES TAKING PLACE.


HEAGY BURRY BOAT RAMP PREPARED FOR MARION COUNTY BOARD OF COUNTY COMMISSIONERS MARION COUNTY FLORIDA	DEMOLITION PLAN	KHA PROJECT 040997022 DECEMBER 2023 SCALE AS SHOWN DESIGNED BY KHA DRAWN BY JSC CHECKED BY JMB	LICENSED PROFESSIONAL RICHARD V. BUSCH, P.E. FLORIDA LICENSE NUMBER 555568	© 2023 KIMLEY-HORN AND ASSOCIATES, INC. 1700 SE 17TH STREET, SUITE 200 PACIFIC, FLORIDA 32121 WWW.KIMLEY-HORN.COM REVISION NO. 00108	KIMLEY-HORN	NO.	REVISIONS	DATE	BY

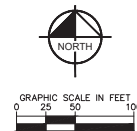

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SIGNING AND MARKING LEGEND:

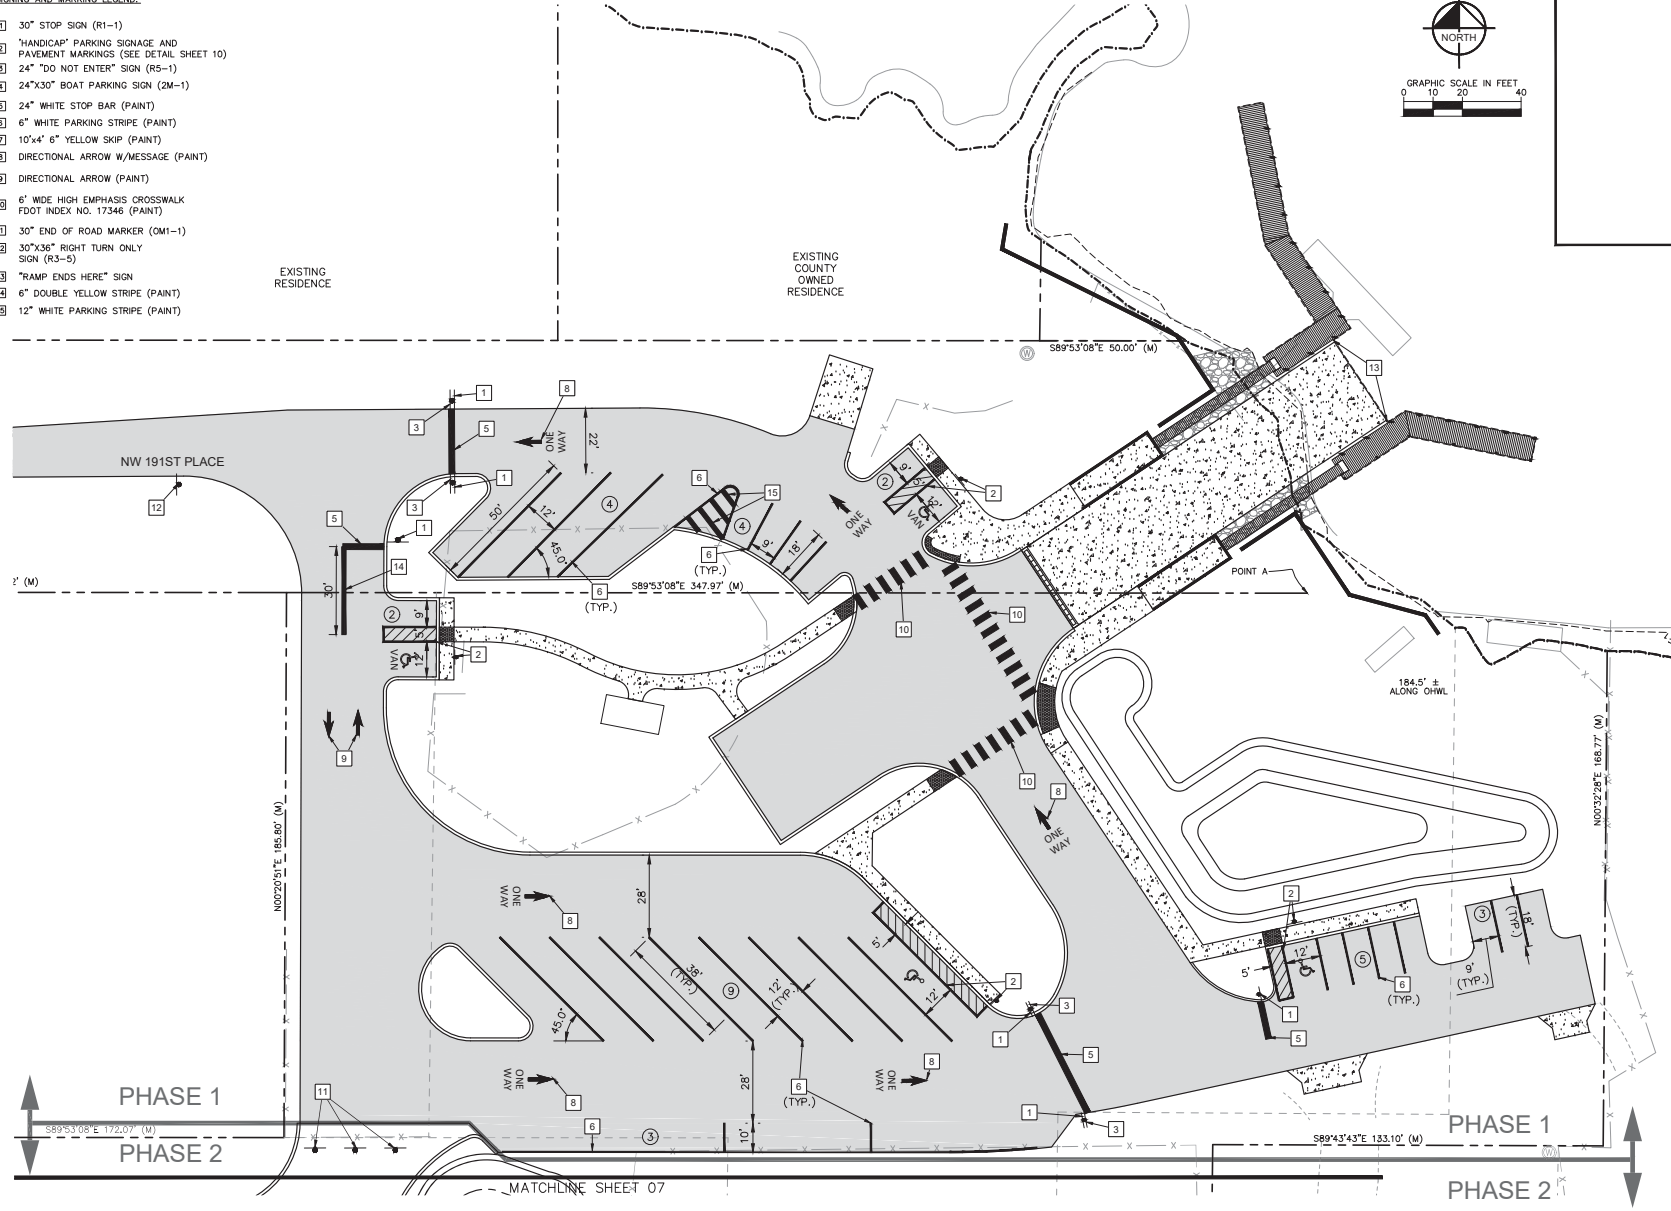- 1 30" STOP SIGN (R1-1)
- 2 "HANDICAP" PARKING SIGNAGE AND PAVEMENT MARKINGS (SEE DETAIL SHEET 10)
- 3 24" "DO NOT ENTER" SIGN (R5-1)
- 4 24"x30" BOAT PARKING SIGN (2M-1)
- 5 24" WHITE STOP BAR (PAINT)
- 6 6" WHITE PARKING STRIPE (PAINT)
- 7 10"x4" 6" YELLOW SKIP (PAINT)
- 8 DIRECTIONAL ARROW W/MESSAGE (PAINT)
- 9 DIRECTIONAL ARROW (PAINT)
- 10 6" WIDE HIGH EMPHASIS CROSSWALK FDOT INDEX NO. 17346 (PAINT)
- 11 30" END OF ROAD MARKER (OM1-1)
- 12 30"x36" RIGHT TURN ONLY SIGN (R3-5)
- 13 "RAMP ENDS HERE" SIGN
- 14 6" DOUBLE YELLOW STRIPE (PAINT)
- 15 12" WHITE PARKING STRIPE (PAINT)



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1901 E. 77TH STREET, SUITE 200, FLORIDA, 33411
PHONE: (848) 440-3400
WWW.KIMLEY-HORN.COM REBERTY NO. 20108

LICENSED PROFESSIONAL
KHA PROJECT: 040997022
DATE: DECEMBER 2023
SCALE: AS SHOWN
DESIGNED BY: KHA
DRAWN BY: DSC
CHECKED BY: RMB
DATE: _____

SIGNING AND MARKING PLAN

HEALY BURY BOAT RAMP
PREPARED FOR:
MARION COUNTY BOARD OF
COUNTY COMMISSIONERS
MARION COUNTY, FLORIDA



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06

HEALY BURY BOAT RAMP - MARION COUNTY MAJOR SITE PLAN

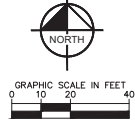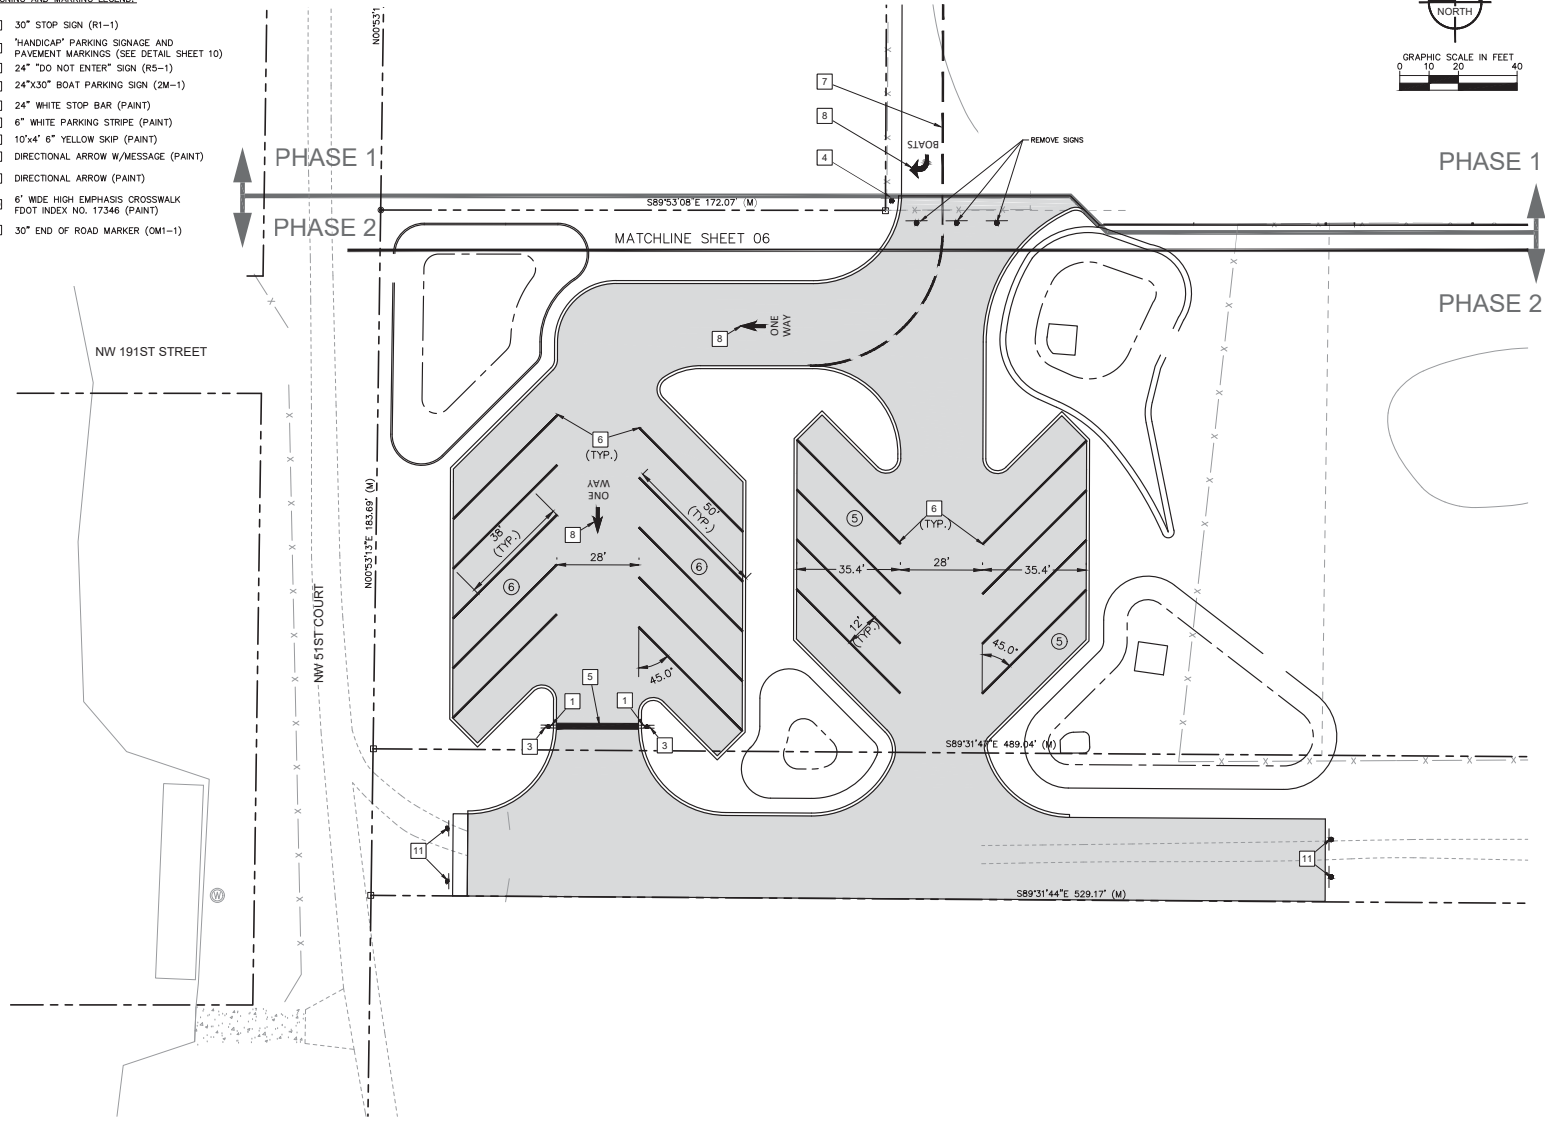REVISIONS
No. DATE BY

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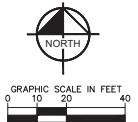
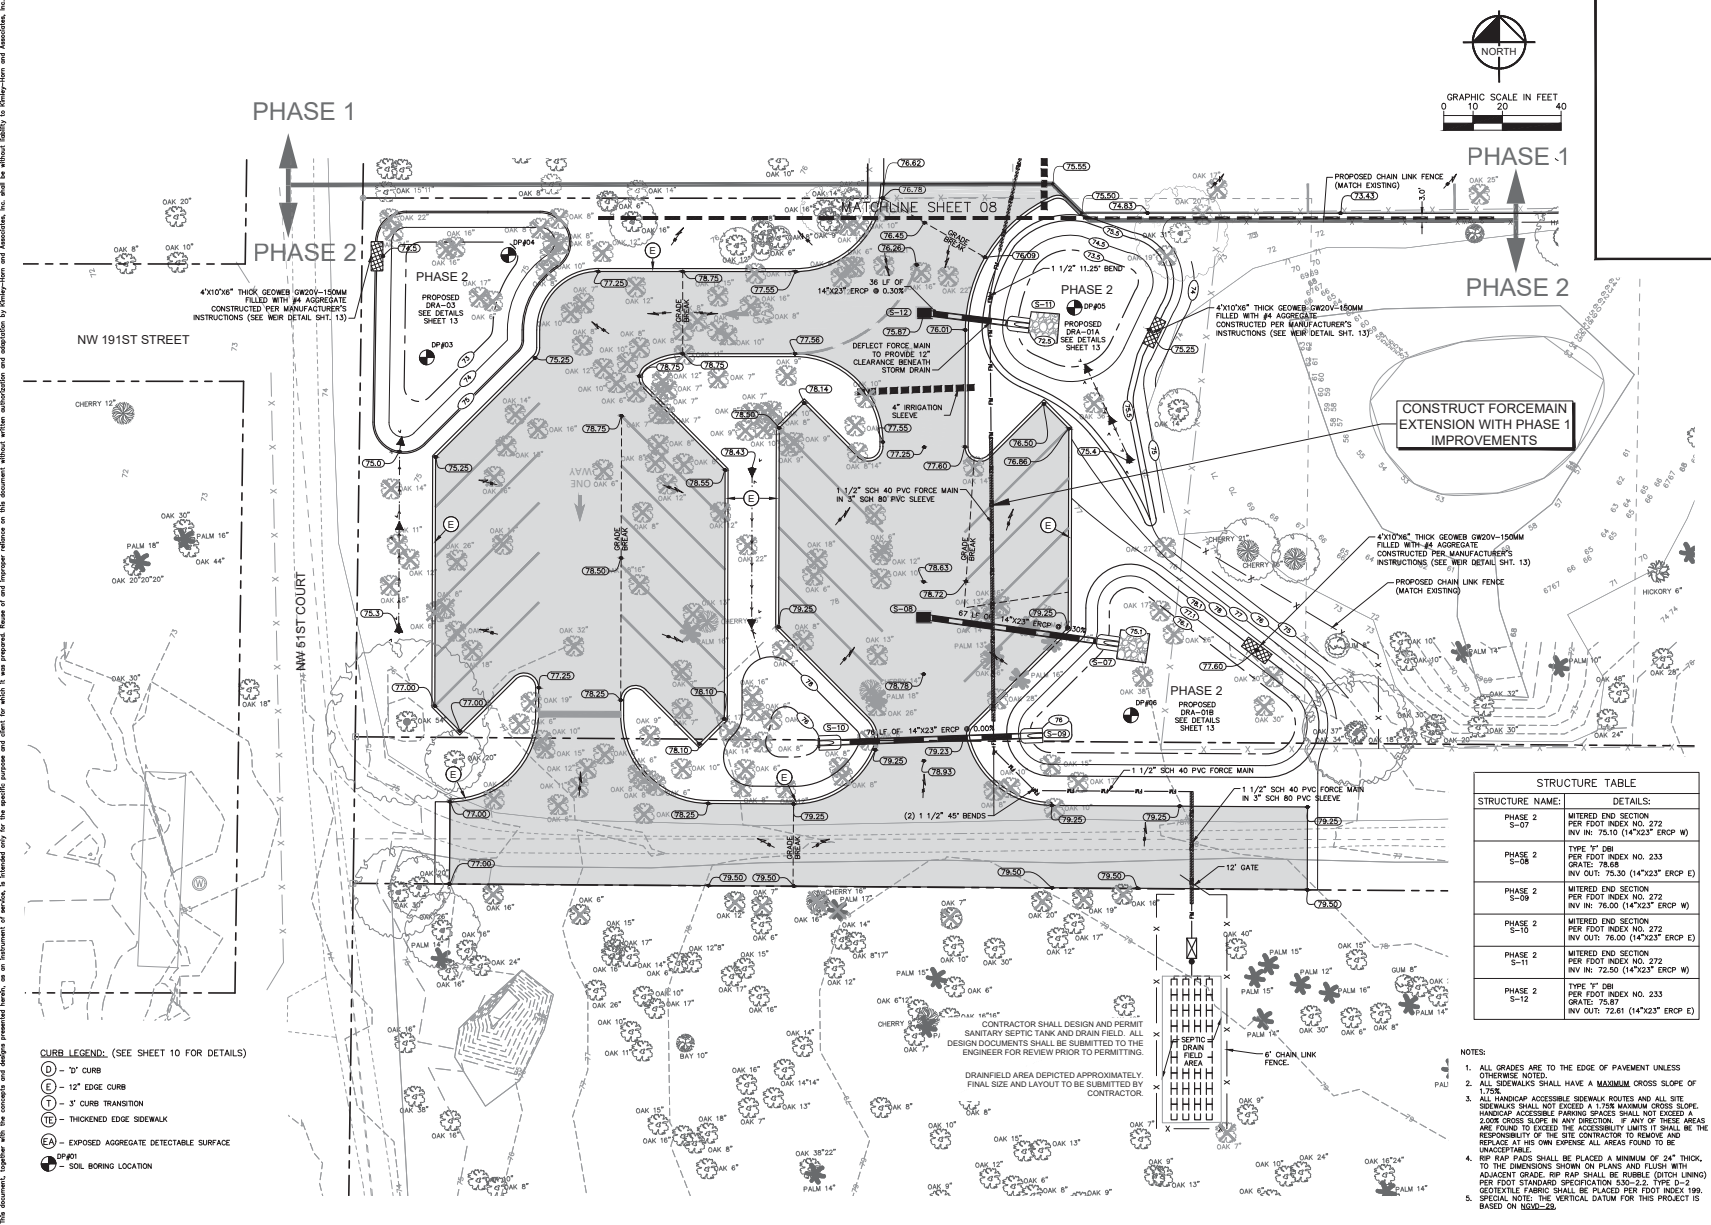
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9	DIRECTIONAL ARROW (PAINT)
10	6" FUTURE HIGH EMPHASIS CROSSWALK DOT INDEX NO. 17346 (PAINT)
11	30" END OF ROAD MARKER (OM1-1)



SHEET NUMBER		07	
HEAVY BURRY BOAT RAMP PREPARED FOR MARION COUNTY BOARD OF COUNTY COMMISSIONERS		SIGNING AND MARKING PLAN	
MARION COUNTY FLORIDA		 Kimley-Horn © 2023 KIMLEY-HORN AND ASSOCIATES, INC. 1705 SE 17TH STREET, SUITE 200, OCALA, FLORIDA 34671 PHONE: 352.206.8000 FAX: 352.206.8001 WWW.KIMLEY-HORN.COM LICENSE NO. 20106	
KHA PROJECT 040997022		LICENSED PROFESSIONAL	
DATE DECEMBER 2023		RICHARD V. BUSCHE, P.E.	
SCALE AS SHOWN		FLORIDA LICENSE NUMBER	
DESIGNED BY		55556	
DRAWN BY		DSC	
CHECKED BY		RVB	
DATE:		DATE:	

HEAGY BURRY BOAT RAMP - MARION COUNTY MAJOR SITE PLAN

THIS DOCUMENT, TOGETHER WITH THE CONCEPTS AND DESIGN PRESENTED HEREIN, IS INTENDED ONLY FOR THE SPECIFIC PURPOSE AND CLIENT FOR WHICH IT WAS PREPARED. IT IS THE RESPONSIBILITY OF THE USER TO OBTAIN NECESSARY PERMITS AND TO VERIFY THE ACCURACY OF ALL INFORMATION PROVIDED HEREIN. THE USER SHALL BE RESPONSIBLE FOR OBTAINING ALL NECESSARY PERMITS AND FOR THE PROTECTION OF THE PUBLIC. THE USER SHALL BE RESPONSIBLE FOR THE PROTECTION OF THE PUBLIC. THE USER SHALL BE RESPONSIBLE FOR THE PROTECTION OF THE PUBLIC.



CONSTRUCT FORCEMAIN
EXTENSION WITH PHASE 1
IMPROVEMENTS

STRUCTURE TABLE	
STRUCTURE NAME:	DETAILS:
PHASE 2 S-07	MITERED END SECTION PER FOOT INDEX NO. 272 INV IN: 75.10 (14"x23" ERCP W)
PHASE 2	TYPE 1" DB PER FOOT INDEX NO. 233 GRATE: 78.68 INV OUT: 75.30 (14"x23" ERCP E)
PHASE 2 S-08	MITERED END SECTION PER FOOT INDEX NO. 272 INV IN: 76.00 (14"x23" ERCP W)
PHASE 2 S-10	MITERED END SECTION PER FOOT INDEX NO. 272 INV OUT: 76.00 (14"x23" ERCP E)
PHASE 2 S-11	MITERED END SECTION PER FOOT INDEX NO. 272 INV IN: 72.50 (14"x23" ERCP W)
PHASE 2 S-12	TYPE 1" DB PER FOOT INDEX NO. 233 GRATE: 75.87 INV OUT: 72.81 (14"x23" ERCP E)

- NOTES:
1. ALL GRADES ARE TO THE EDGE OF PAVEMENT UNLESS OTHERWISE NOTED.
 2. ALL SIDEWALKS SHALL HAVE A MAXIMUM CROSS SLOPE OF 1.75%.
 3. ALL HANDICAP ACCESSIBLE SIDEWALK ROUTES AND ALL SITE SIDEWALKS SHALL NOT EXCEED A 1.75% MAXIMUM CROSS SLOPE. HANDICAP ACCESSIBLE PARKING SPACES SHALL NOT EXCEED A 2.00% CROSS SLOPE IN ANY DIRECTION. IF ANY OF THESE AREAS ARE FOUND TO EXCEED THE ACCESSIBILITY LIMITS IT SHALL BE THE RESPONSIBILITY OF THE SITE CONTRACTOR TO REGRADE AND REPLACE AT HIS OWN EXPENSE ALL AREAS FOUND TO BE UNACCESSIBLE.
 4. RIP RAP PADS SHALL BE PLACED A MINIMUM OF 24" THICK. TO THE DIMENSIONS SHOWN ON PLANS AND FLUSH WITH ADJACENT GRADE. RIP RAP SHALL BE RUBBLE (DOTCH LINING) PER FOOT STANDARD SPECIFICATION 330-2.2. TYPE 5-2. GEOTEXTILE FABRIC SHALL BE PLACED PER FOOT INDEX 199.
 5. SPECIAL NOTE: THE VERTICAL DATUM FOR THIS PROJECT IS BASED ON NGVD-83.

- CURB LEGEND: (SEE SHEET 10 FOR DETAILS)
- (D) - 10" CURB
 - (E) - 12" EDGE CURB
 - (T) - 3" CURB TRANSITION
 - (TL) - THICKENED EDGE SIDEWALK
 - (EA) - EXPOSED AGGREGATE DETECTABLE SURFACE
 - (PB) - SOIL BORING LOCATION

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WWW.KIMLEY-HORN.COM REGISTRY NO. 20108

LICENSED PROFESSIONAL
KHA PROJECT
040957022
DATE
DECEMBER 2023
SCALE
AS SHOWN
DESIGNED BY
KHA
DRAWN BY
DSC
CHECKED BY
RVE
DATE

PAVING, GRADING
AND DRAINAGE
PLAN

HEAVY BURRY BOAT RAMP
PREPARED FOR
MARION COUNTY BOARD OF
COUNTY COMMISSIONERS
MARION COUNTY
FLORIDA

SHEET NUMBER
09

HEAVY BURRY BOAT RAMP - MARION COUNTY MAJOR SITE PLAN



NO.	REVISIONS	DATE

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TABLE OF SIDEWALK THICKNESS - "T"	
LOCATION	"T"
RESIDENTIAL AREAS	4"
AT INTERSECTIONS AND OTHER AREAS	6"


NOTE:
CONCRETE TO BE 3,000 P.S.I. AT 28 DAYS

TABLE OF SIDEWALK JOINTS	
TYPE	LOCATION
"X"	P.C. AND P.T. OF CURVES
"Y"	5'-0" CENTER TO CENTER ON SIDEWALKS NOT LESS THAN 4' AND NOT GREATER THAN 100'
"Z"	WHERE SIDEWALK MEETS CONCRETE CURB, DRIVEWAYS AND SIMILAR STRUCTURES, JUNCTION OF EXISTING AND NEW SIDEWALKS AT INTERVALS NOT GREATER THAN 100'

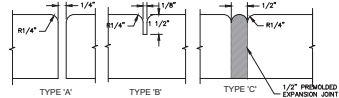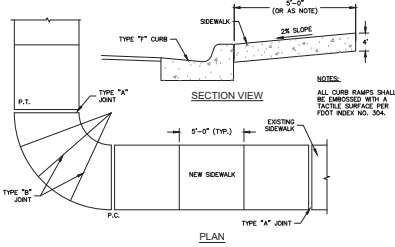


SIDEWALK JOINTS

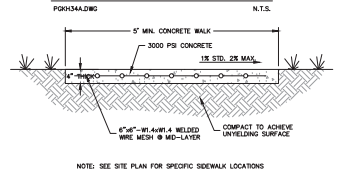SIDEWALK CONSTRUCTION




TYPICAL SIDEWALK SECTION

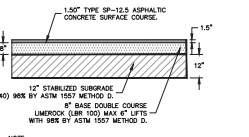POH038A.DWG N.T.S.




TYPICAL PAVEMENT SECTION
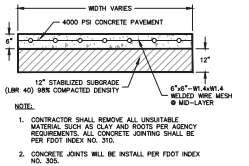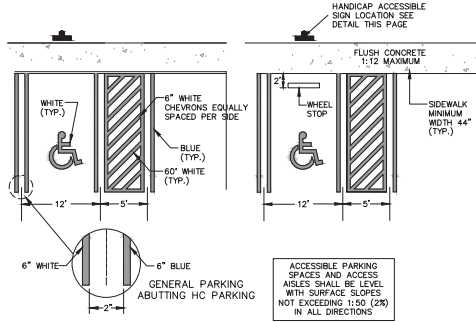
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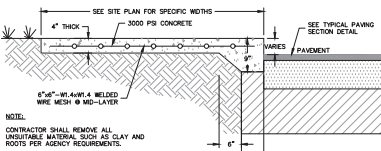
TYPICAL CONCRETE PAVEMENT SECTION



HANDICAP SPACE STRIPING


DETAIL

N.T.S.





RAISED SIDEWALK AND PAVEMENT SECTION

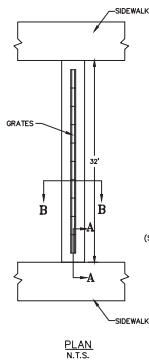POH041A.DWG N.T.S.




TRENCH DRAIN

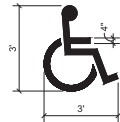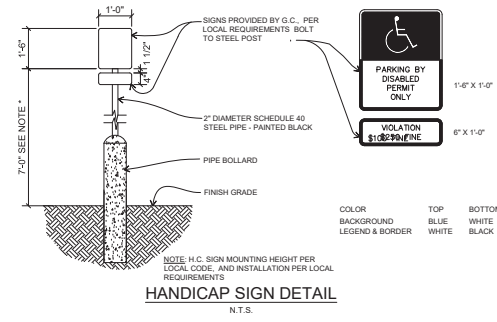N.T.S.




HANDICAP SYMBOL

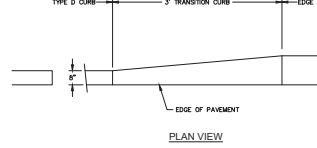N.T.S.




TRANSITION TYPE "D" CURB TO EDGE CURB

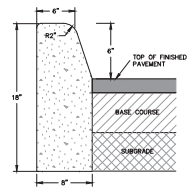POH042A.DWG N.T.S.



TYPE "D" CURB

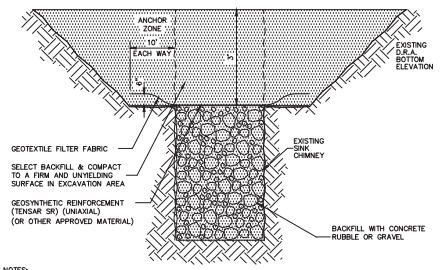POH022A.DWG N.T.S.



TYPICAL SINK CHIMNEY REPAIR DETAIL

N.T.S.

Kimley-Horn

LICENSED PROFESSIONAL
RICHARD V. BUSCH, P.E.
DECEMBER 2023
SCALE AS SHOWN
DESIGNED BY KHA
DRAWN BY DSC
CHECKED BY RVE
DATE

CONSTRUCTION DETAILS

HEAVY BURRY BOAT RAMP
PREPARED FOR
MARION COUNTY BOARD OF
COUNTY COMMISSIONERS
MARION COUNTY
FLORIDA

SHEET NUMBER
10

HEAVY BURRY BOAT RAMP - MARION COUNTY MAJOR SITE PLAN



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PHONE: 352-436-3000

KHA PROJECT 040997022	LICENSED PROFESSIONAL
DATE DECEMBER 2023	<u>RICHARD V. BUSOHE, P.E.</u>
SCALE AS SHOWN	FLORIDA LICENSE NUMBER 58568
DESIGNED BY KHA	
DRAWN BY DSC	
CHECKED BY RVB	DATE:

CONSTRUCTION DETAILS


HEAGY BURRY BOAT RAMP
PREPARED FOR
MARION COUNTY BOARD OF
COUNTY COMMISSIONERS
MARION COUNTY FLORIDA
BURRY BOAT RAMP - MARION COUNTY MAINTENANCE

SHEET NUMBER
12


LOCATION	LOCATION
HEAGY BURRY BOAT RAMP - MARION COUNTY MAJOR SITE PLAN	

No.	REVISIONS	DATE	BY
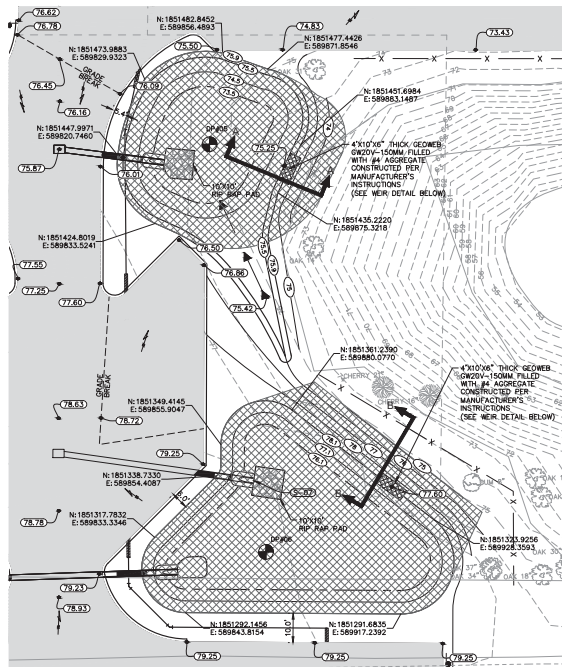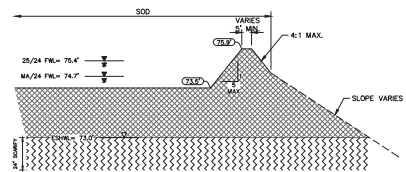
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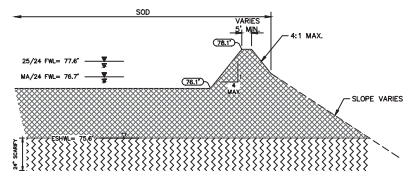


PHASE 2



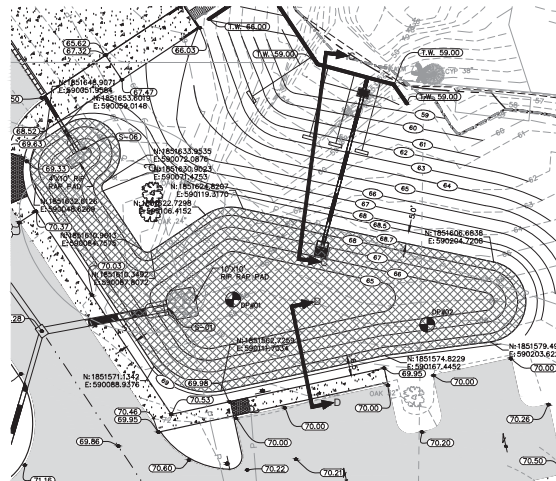
DRA-01A SECTION A-A
N.T.S.

OVER EXCAVATE POND BOTTOM TO ELEVATION 73.0± AND BACKFILL WITH CLEAN, FREE-DRAINING SAND ($k_H=15$ FEET/DAY MINIMUM) TO ELEVATION 73.5. EXTEND CLEAN, FREE-DRAINING SAND THROUGH POND BERM TO NATURAL GROUND.




DRA-01B SECTION B-B
N.T.S.


OVER EXCAVATE POND BOTTOM TO ELEVATION 75.6± AND BACKFILL WITH CLEAN, FREE-DRAINING SAND ($K_H=15$ FEET/DAY MINIMUM) TO ELEVATION 76.1. EXTEND CLEAN, FREE-DRAINING SAND THROUGH POND BERM TO NATURAL GROUND.




PHASE 1

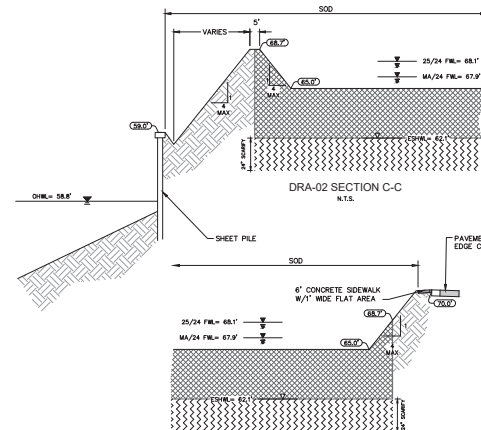


A-02 SECTION D-D
N.T.S.

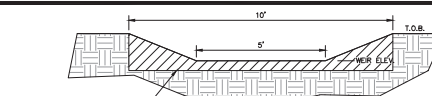

WEIR DETAIL

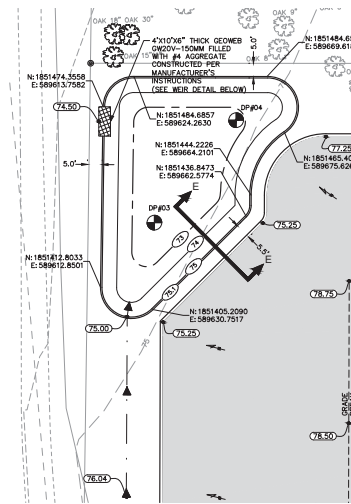


PHASE 2

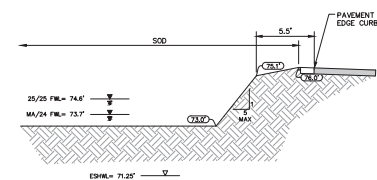

DRA-03 SECTION E-E
N.T.S.

NOTES:

1. STORMWATER RETENTION PONDS ARE DESIGNED TO INFILTRATE STORMWATER. THE PONDS ARE SUBSCEPTIBLE TO CLOGGING FROM CONSTRUCTION DEBRIS. THEREFORE, IT REQUIRES A SPECIAL EXCAVATION PROCEDURE AS FOLLOWS:
 - a. EXCAVATION SHALL BE CONDUCTED TO THE BOTTOM OF THE POND TO THE FINISH POND BOTTOM ELEVATION.
 - b. AFTER THE POND IS EXCAVATED, MATERIALS CONTRIBUTING TO THE POND ARE STABILIZED, EXCAVATE, THE REMAINING INTERIOR SIDE SLOPES AND POND BOTTOM TO THE OVER-EXCAVATION ELEVATIONS SHOWN. THIS SOIL MUST BE REMOVED IN A MANNER THAT ASSURES THAT THERE IS NO FURTHER CONTAMINATION OF THE POND. WASTE HASSED IN THE POND DURING CONSTRUCTION ARE REMOVED.
2. EXCAVATION POND BOTTOMS AT THE ELEVATIONS SHOWN TO A MINIMUM DEPTH OF:
 - a. BAYING CLEAN, FINE DRAINING SAND TO FINAL GRADE PER DETAILS THIS SHEET; DO NOT OVER COMPACT.
 - b. FINISH GRADE ALL POND SLOPES AND 500' MAX DISTURBED AREAS.
3. 2R-P-RAP SHALL BE PLACED A MINIMUM OF 24" THICK, TO THE DIMENSIONS SHOWN ON PLANS AND FLUSH WITH ADJACENT GRADE. 2R-P-RAP SHALL BE RUBBLE (DITCH LINING) PER STANDARD SPECIFICATION 530-2.2. TYPE 2-G GRANULAR FILL SHALL BE PLACED PER STANDARD SPECIFICATION 530-2.2.
3. SHOULD ANY LIMEROCK BE ENCOUNTERED, SEE TYPICAL SKIN CHIMEY REPAIR DETAIL ON SHEET 10.

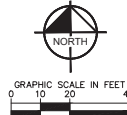
 AREA OF OVER EXCAVATION
(SEE NOTE 1 ABOVE)

CALL TWO (2)
BUSINESS DAYS
BEFORE YOU DIG

IT'S THE LAW!
DIAL 811

Know what's below.
Call before you dig.

SUNSHINE STATE ONE CALL OF FLORIDA, INC.



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PHONE: 352-434-3000

DATE	04/09/2022
DECEMBER 2023	
SCALE AS SHOWN	
DESIGNED BY KHA	
DRAWN BY DSC	
CHECKED BY RVB	
DATE:	

RICHARD V. BUSCHE, P.E.

FLORIDA LICENSE NUMBER 58568

REGISTERED PROFESSIONAL

POND DETAILS



BURRY BOAT RAMP
PREPARED FOR
COUNTY BOARD OF
COMMISSIONERS
COUNTY FLORIDA

HEAGY
MARION
COUNTY
MARION C

SHEET NUMBER
13

HEAGY BURRY BOAT RAMP - MARION COUNTY MAJOR SITE PLAN

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- NOTES:
1. BOAT RAMP SHALL BE BY TEDDER BOAT RAMP SYSTEMS, INC. OR APPROVED EQUAL. SUBSTITUTION OF ALTERNATE SYSTEM MUST BE APPROVED BY OWNER AT BIDDING. (352) 245-8559.
 2. ALUMINUM TOP DECKED FULL FLOATING DOCK AND GANGWAY AS MANUFACTURED BY GATOR DOCK & MARINE, LLC OR OWNER APPROVED EQUAL (407) 323-0190.
 3. FULL SHOP DRAWING FOR ALL RAMP AND DOCK COMPONENTS MUST BE APPROVED IN WRITING BY ENGINEER AND OWNER PRIOR TO ORDERING MATERIALS.
 4. ANY SUBSTITUTIONS OF PROPOSED APPROVED EQUALS MUST BE APPROVED BY OWNER AT BIDDING.
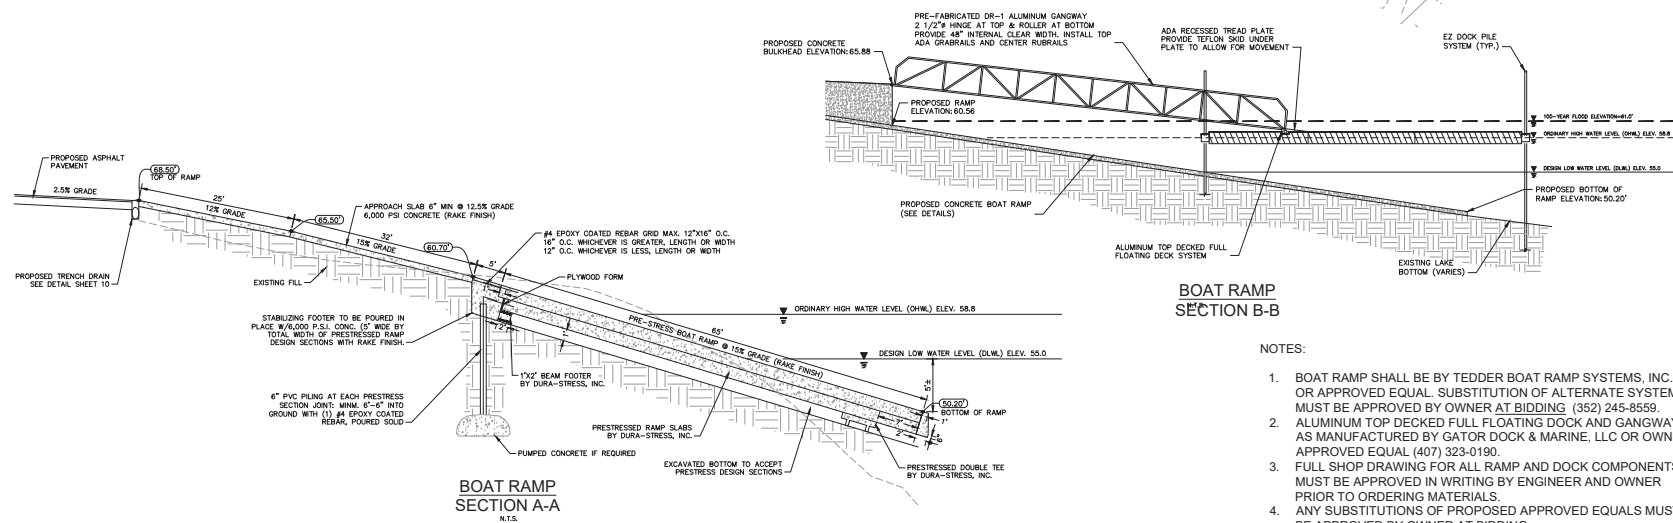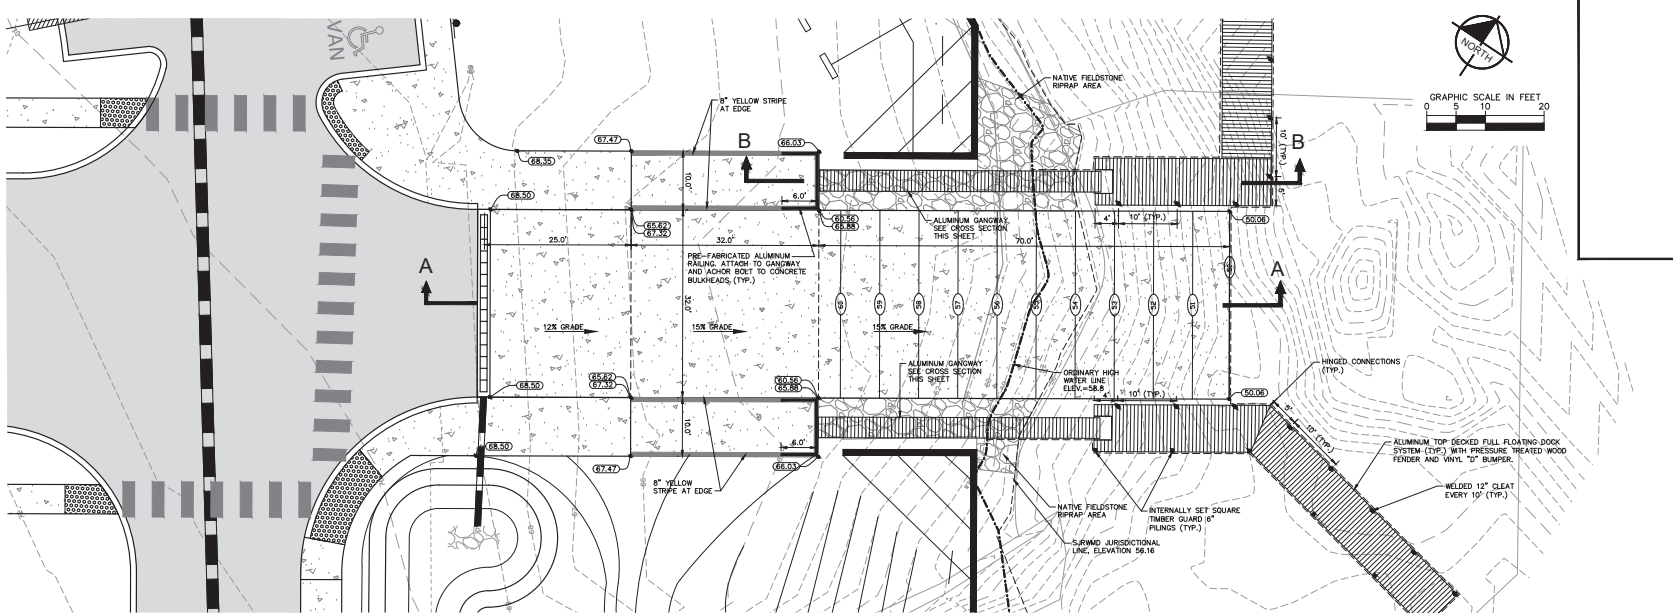
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1700 E. 77TH STREET, SUITE 200, FLORIDA, 33171
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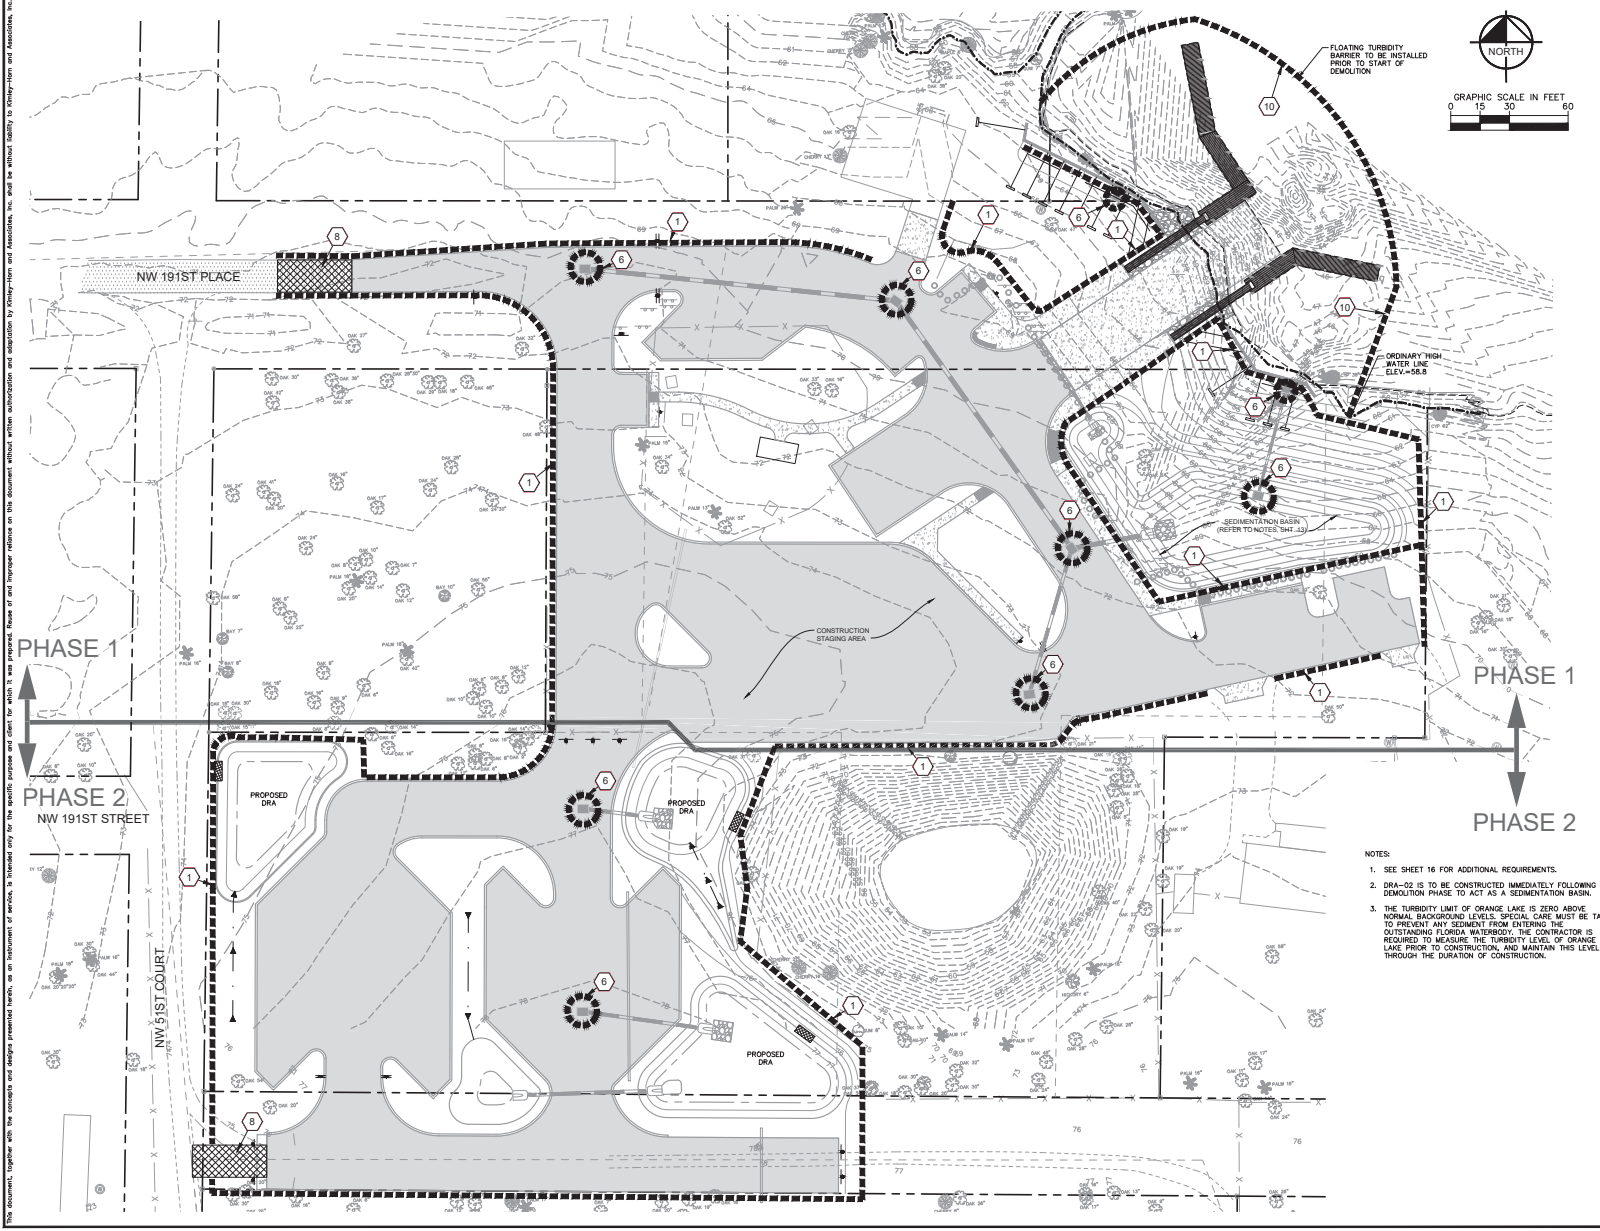
LICENSED PROFESSIONAL
KHA PROJECT 040997022
DATE 04/09/2022
SCALE AS SHOWN
DESIGNED BY KHA
DRAWN BY DSC
CHECKED BY RMB
RICHARD V. BUSCH, P.E.
FLORIDA LICENSE NUMBER 555568

BOAT RAMP DETAILS

HEAVY BURRY BOAT RAMP
PREPARED FOR
MARION COUNTY BOARD OF
COUNTY COMMISSIONERS
MARION COUNTY
FLORIDA

SHEET NUMBER
14

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LICENSED PROFESSIONAL
KHA PROJECT
040997022
DECEMBER 2023
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EROSION CONTROL PLAN

HEAGY BURRY BOAT RAMP
PREPARED FOR
MARION COUNTY BOARD OF
COUNTY COMMISSIONERS
MARION COUNTY
FLORIDA

SHEET NUMBER
15

HEAGY BURRY BOAT RAMP - MARION COUNTY MAJOR SITE PLAN

NO.	REVISIONS	DATE	BY

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TIMING OF SEDIMENT - CONTROL PRACTICES:

SEDIMENT CONTROL PRACTICES SHALL BE FUNCTIONAL THROUGHOUT EARTH-DISTURBING ACTIVITY.

SETTLING FACILITIES, PERIMETER CONTROLS, AND OTHER PRACTICES INTENDED TO TRAP SEDIMENT SHALL BE IMPLEMENTED AS THE FIRST STEP OF GRADING AND WITHIN SEVEN DAYS FROM THE START OF GRUBBING. THEY SHALL CONTINUE TO FUNCTION UNTIL THE UPSLOPE DEVELOPMENT AREA IS RE-STABILIZED.

STABILIZATION OF NON STRUCTURAL PRACTICES:

CONTROL PRACTICES SHALL PRESERVE EXISTING VEGETATION WHERE ATTAINABLE AND DISTURBED AREAS SHALL BE RE-VEGETATED AS SOON AS PRACTICAL AFTER GRADING OR CONSTRUCTION, BUT NO LATER THAN SEVEN DAYS.

DENUDED AREAS SHALL HAVE SOIL STABILIZATION APPLIED WITHIN FOURTEEN DAYS IF THEY ARE TO REMAIN DORMANT FOR MORE THAN FORTY-FIVE DAYS. PERMANENT OR TEMPORARY SOIL STABILIZATION SHALL BE APPLIED TO DENUDED AREAS WITHIN FOURTEEN DAYS AFTER FINAL GRADE IS REACHED ON ANY PORTION OF THE SITE, AND SHALL ALSO BE APPLIED WITHIN SEVEN DAYS TO DENUDED AREAS WHICH MAY NOT BE AT FINAL GRADE, BUT WILL REMAIN DORMANT FOR LONGER THAN FORTY-FIVE DAYS.

SEDIMENT BARRIERS:

SHEET FLOW RUNOFF FROM DENUDED AREAS SHALL BE INTERCEPTED BY SEDIMENT BARRIERS.

SEDIMENT BARRIERS SUCH AS SEDIMENT FENCES OR DIVERSIONS TO SETTLING FACILITIES SHALL PROTECT ADJACENT PROPERTIES AND WATER RESOURCES FROM SEDIMENT TRANSPORTED BY SHEET FLOW.

ALL STORM SEWER INLETS WHICH ACCEPT WATER RUNOFF FROM THE DEVELOPMENT AREA SHALL BE PROTECTED SO THAT SEDIMENT-LADEN WATER WILL NOT ENTER THE STORM SYSTEM WITHOUT FIRST BEING PONDED AND FILTERED.

TEMPORARY EROSION CONTROL FEATURES SHALL BE ACCEPTABLY MAINTAINED AND SHALL BE REMOVED OR REPLACED WHEN DIRECTED BY THE ENGINEER AT NO COST TO THE OWNER. ALL WORK SHALL BE PERFORMED IN ACCORDANCE WITH THE SPECIFICATIONS.

ALL SOIL STOCKPILES SHALL BE PROTECTED FROM EROSION BY PERIMETER CONTROL DEVICES SUCH AS STRAW BALE DIKES OR FILTER FABRIC FENCES. THESE PERIMETER CONTROL DEVICES SHALL BE MAINTAINED THROUGHOUT THE LIFE OF THE PROJECT.

PERMANENT VEGETATION:

PERMANENT VEGETATION SHALL NOT BE CONSIDERED ESTABLISHED UNTIL GROUND COVER IS ACHIEVED WHICH, IN THE OPINION OF THE ENGINEER, PROVIDES ADEQUATE COVER AND IS MATURE ENOUGH TO CONTROL SOIL EROSION SATISFACTORILY AND TO SURVIVE ADVERSE WEATHER CONDITIONS.

CONSTRUCTION ACCESS ROUTES:

MEASURES SHALL BE TAKEN TO PREVENT SOIL TRANSPORT ONTO SURFACES OR PUBLIC ROADS.

INSPECTION SCHEDULE:

1. SILT FENCE AND STRUCTURAL PROTECTION – INSPECT EVERY 7 DAYS OR AFTER EACH RAINSTORM PRODUCING RUNOFF. REPAIR AS REQUIRED.
2. INLET PROTECTION – INSPECT FOR SEDIMENT ACCUMULATION AFTER EACH RAINFALL AND DAILY DURING CONTINUED RAINFALL. REPAIR OR REPLACE WHEN WATER FLOW IS RESTRICTED BY SEDIMENT.
3. VEGETATIVE PLANTING – INSPECT AFTER SPROUTING OCCURS AND REPLANT BARE AREAS. INSPECT ESTABLISHED COVER EVERY 15 DAYS FOR DAMAGE; REPLANT AS REQUIRED. MAINTAIN ESTABLISHED COVER AT MAXIMUM 6" HEIGHT. IRRIGATE AS REQUIRED DURING DRY PERIODS TO MAINTAIN LIVE VEGETATION.

CONSTRUCTION SEQUENCE:

1. INSTALL SEDIMENT CONTROL MEASURES.
2. INSTALL TREE PROTECTION.
3. PERFORM DEMOLITION ACTIVITIES.
4. STABILIZE SITE WITH TEMPORARY VEGETATION AS NEEDED.
5. INSTALL STORMWATER MANAGEMENT MEASURES.
6. CONSTRUCT PARKING AND RECREATION IMPROVEMENTS.
7. INSTALL PERMANENT VEGETATION.
8. PERFORM CONTINUING MAINTENANCE THROUGHOUT ALL CONSTRUCTION OPERATIONS.

DITCH BARRIERS:

BALES SHALL BE PLACED IN A SINGLE ROW, LENGTHWISE, ORIENTED PERPENDICULAR TO THE CONTOUR, WITH ENDS OF ADJACENT BALES TIGHTLY ABUTTING ONE ANOTHER.

THE REMAINING STEPS FOR INSTALLING A SYNTHETIC BALE BARRIER FOR SHEET FLOW APPLICATIONS APPLY HERE, WITH THE FOLLOWING ADDITION. THE STRAW BALES SHALL BE INSTALLED SUCH THAT UNDERCUTTING BENEATH THE BALES IS MINIMIZED BY THE USE OF ROCK CHECK DAMS PLACED ADJACENT TO THE STRAW BALES.

THE BARRIER SHALL BE EXTENDED TO SUCH A LENGTH THAT THE BOTTOMS OF THE END BALES ARE HIGHER IN ELEVATION THAN THE TOP OF THE LOWEST MIDDLE BALE TO ASSURE THAT SEDIMENT-LADEN RUNOFF WILL FLOW EITHER THROUGH OR OVER THE BARRIER BUT NOT AROUND IT.

MAINTENANCE:

SYNTHETIC BALES SHALL BE INSPECTED IMMEDIATELY AFTER EACH ONE-HALF INCH RAINFALL AND AT LEAST DAILY DURING PROLONGED RAINFALL.

CLOSE ATTENTION SHALL BE PAID TO THE REPAIR OF DAMAGED BALES, END RUNS AND UNDERCUTTING BENEATH BALES.

NECESSARY REPAIRS TO BARRIERS OR REPLACEMENT OF BALES SHALL BE ACCOMPLISHED PROMPTLY.

SEDIMENT DEPOSITS SHOULD BE REMOVED AFTER EACH RAINFALL. THEY MUST BE REMOVED WHEN THE LEVEL OF DEPOSITION REACHES APPROXIMATELY ONE-HALF THE HEIGHT OF THE BARRIER.

ANY SEDIMENT DEPOSITS REMAINING IN PLACE AFTER THE SYNTHETIC BALE BARRIER IS NO LONGER REQUIRED SHALL BE DRESSED TO CONFORM TO THE EXISTING GRADE, PREPARED AND SEEDDED.

SEDIMENT FENCE:

1. THE HEIGHT OF A SEDIMENT FENCE SHALL NOT EXCEED 36-INCHES (HIGHER FENCES MAY IMPOUND VOLUMES OF WATER SUFFICIENT TO CAUSE FAILURE OF THE STRUCTURE).
2. THE FILTER FABRIC SHALL BE PURCHASED IN A CONTINUOUS ROLL CUT TO THE LENGTH OF THE BARRIER TO AVOID THE USE OF JOINTS. WHEN JOINTS ARE NECESSARY, FILTER CLOTH SHALL BE SPLICED TOGETHER ONLY AT A SUPPORT POST, WITH A MINIMUM 6-INCH OVERLAP, AND SECURELY SEALED.
3. POSTS SHALL BE SPACED A MAXIMUM OF 10 FEET APART AT THE BARRIER LOCATION AND DRIVEN SECURELY INTO THE GROUND (MINIMUM OF 12 INCHES). WHEN EXTRA STRENGTH FABRIC IS USED WITHOUT THE WIRE SUPPORT FENCE, POST SPACING SHALL NOT EXCEED 6 FEET.
4. A TRENCH SHALL BE EXCAVATED APPROXIMATELY 4 INCHES WIDE AND 4 INCHES DEEP ALONG THE LINE OF POSTS AND UPSLOPE FROM THE BARRIER.
5. WHEN STANDARD STRENGTH FILTER FABRIC IS USED, A WIRE MESH SUPPORT FENCE SHALL BE FASTENED SECURELY TO THE UPSLOPE SIDE OF THE POSTS USING HEAVY DUTY WIRE STAPLES AT LEAST 1-INCH LONG, THE WIRES OR HOG RINGS. THE WIRE SHALL EXTEND INTO THE TRENCH A MINIMUM OF 2 INCHES AND SHALL NOT EXTEND MORE THAN 36 INCHES ABOVE THE ORIGINAL GROUND SURFACE.
6. THE STANDARD STRENGTH FILTER FABRIC SHALL BE STAPLED OR WIRED TO THE FENCE, AND 8-INCHES OF THE FABRIC SHALL BE EXTENDED INTO THE TRENCH. THE FABRIC SHALL NOT EXTEND MORE THAN 36 INCHES ABOVE THE ORIGINAL GROUND SURFACE. FILTER FABRIC SHALL NOT BE STAPLED TO EXISTING TREES.
7. WHEN EXTRA STRENGTH FILTER FABRIC AND CLOSURE POST SPACING ARE USED, THE WIRE MESH SUPPORT FENCE MAY BE ELIMINATED IN SUCH A CASE, THE FILTER FABRIC IS STAPLED OR WIRED DIRECTLY TO THE POSTS WITH ALL OTHER PROVISIONS OF ITEM NO. 6 APPLYING.
8. THE TRENCH SHALL BE BACKFILLED AND SOIL COMPACTED OVER THE FILTER FABRIC.
9. SEDIMENT FENCES SHALL BE REMOVED WHEN THEY HAVE SERVED THEIR USEFUL PURPOSE, BUT NOT BEFORE THE UPSLOPE AREA HAS BEEN PERMANENTLY STABILIZED.

MAINTENANCE:

SEDIMENT FENCES AND FILTER BARRIERS SHALL BE INSPECTED IMMEDIATELY AFTER EACH ONE-HALF INCH RAINFALL AND AT LEAST DAILY DURING PROLONGED RAINFALL. ANY REQUIRED REPAIRS SHALL BE MADE IMMEDIATELY.

SHOULD THE FABRIC ON A SEDIMENT FENCE OR FILTER BARRIER DECOMPOSE OR BECOME INEFFECTIVE PRIOR TO THE END OF THE EXPECTED USABLE LIFE AND THE BARRIER IS STILL NECESSARY, THE FABRIC SHALL BE REPLACED PROMPTLY.

SEDIMENT DEPOSITS SHOULD BE REMOVED AFTER EACH STORM EVENT. THEY MUST BE REMOVED WHEN DEPOSITS REACH APPROXIMATELY ONE-HALF THE HEIGHT OF THE BARRIER.

ANY SEDIMENT DEPOSITS REMAINING IN PLACE AFTER THE SEDIMENT FENCE OR FILTER BARRIER IS NO LONGER REQUIRED SHALL BE DRESSED TO CONFORM WITH THE EXISTING GRADE, PREPARED AND SEEDDED OR SODDED AS PER PLAN.

ADDITIONAL MEASURES:

THIS PLAN AND NARRATIVE REPRESENTS THE MINIMUM AMOUNT OF EROSION AND SEDIMENT CONTROL MEASURES, IN THE OPINION OF THE ENGINEER, THAT MAY BE NECESSARY UNDER FAVORABLE WEATHER CONDITIONS. THE CONTRACTOR IS RESPONSIBLE FOR ANY ADDITIONAL MEASURES OR PRACTICES THAT MAY BE NECESSARY TO CONTROL EROSION, TURBID DISCHARGE, FUGITIVE PARTICULATES, ETC. TO FULLY COMPLY WITH ALL GOVERNMENTAL RULES AND/OR PERMIT REQUIREMENTS.

TREE PROTECTION:

FOR ALL TREES SHOWN TO REMAIN:

1. CONSTRUCT BARRICADES AROUND ALL TREES NOT SHOWN TO BE REMOVED. INSTALL BARRICADES AND OBTAIN A TREE PERMIT PRIOR TO ANY CLEARING.
2. LOCATE BARRICADES AT THE DRIP LINE OF TREES OR AS CLOSE AS PRACTICAL. BARRICADES SHALL BE APPROXIMATELY 4' IN HEIGHT.
3. BARRICADES MAY BE CONSTRUCTED OF ANY SUITABLE MATERIAL WHICH IS RIGID ENOUGH TO WITHSTAND THE ELEMENTS AND THE CONSTRUCTION PERIOD. HIGH VISIBILITY CONSTRUCTION FENCE IS ALLOWED FOR TREE PROTECTION.
4. BARRICADES FOR GROUPS OF TREES OR AREAS OF NO CLEARING MAY BE CONSTRUCTED OF 4' POLYETHYLENE BARRIER FENCE ATTACHED TO 1-POSTS SPACED AT MAXIMUM 10' SPACING. ATTACH FENCE MATERIAL TO POSTS WITH A WIRE OR PLASTIC TIES.
5. NO BUILDING MATERIALS, TRASH, EQUIPMENT, WASTE OR OTHER OBJECTS SHALL BE PLACED, PARKED, DUMPED, OR STORED INSIDE TREE BARRIERS. NO VEHICULAR TRAFFIC OR PARKING IS ALLOWED WITHIN THE ROOT ZONES OF THE TREES BEFORE, DURING OR AFTER CONSTRUCTION.

EROSION AND SEDIMENT CONTROL NARRATIVE:

PLAN DESIGNER: KIMLEY-HORN AND ASSOCIATES INC.
1700 SE 17TH STREET, SUITE 200
OCALA, FLORIDA 34471
PHONE: 352-438-3000

OWNER/
DEVELOPER: MARION COUNTY BOARD OF COUNTY COMMISSIONERS
801 SE 25TH AVENUE
OCALA, FL 34471

ADJACENT
AREAS: THE SITE IS BORDERED ON THE NORTH AND WEST BY RESIDENTIAL, ON THE EAST BY ORANGE LAKE, AND THE SOUTH BY UNDEVELOPED COUNTY OWNED LANDS.

EROSION
CONTROL
MEASURE: EROSION AND SITE RUNOFF WILL BE CONTROLLED BY THE USE OF SEDIMENT FENCING, FLOATING TURBIDITY BARRIER AND STABILIZED VEGETATIVE COVER.

SITE CONTACT: JIM COUILLARD, DIRECTOR/LANDSCAPE ARCHITECT
MARION COUNTY PARKS AND RECREATION
111 SE 25TH AVENUE
OCALA, FL 34471
PHONE: 352-671-8560
FAX: 352-671-8550

POLLUTION PREVENTION:

THE NATIONAL POLLUTANT DISCHARGE ELIMINATION SYSTEM (NPDES) PROGRAM IS REGULATED THROUGH THE FLORIDA DEPARTMENT OF ENVIRONMENTAL PROTECTION (FDEP). IF YOUR CONSTRUCTION ACTIVITY MEETS THE FOLLOWING CRITERIA YOU WILL BE REQUIRED TO SUBMIT A NOTICE OF INTENT (NOI) AND PREPARE A STORM WATER POLLUTION PREVENTION PLAN (SWPPP). FOR MORE INFORMATION PLEASE VISIT FDEP'S WEBSITE AT WWW.DEP.STATE.FL.US/WATER/STORMWATER/NPDES:

1. CONTRIBUTES STORM WATER DISCHARGE TO SURFACE WATERS OF THE STATE OR INTO A MUNICIPAL SEPARATE STORM SEWER SYSTEM (MS4); AND
2. DISTURBS ONE OR MORE ACRES OF LAND INCLUDING LESS THAN ONE ACRE IF ACTIVITY IS PART OF A LARGE COMMON PLAN OF DEVELOPMENT OR SALE THAT WILL MEET OR EXCEED A ONE ACRE THRESHOLD. DISTURBANCE INCLUDES CLEARING, GRADING AND EXCAVATING.

Kimley»Horn
© 2023 KIMLEY-HORN AND ASSOCIATES, INC.
1700 SE 17TH STREET, SUITE 200
OCALA, FLORIDA 34471
PHONE: 352-438-3000
WWW.KIMLEY-HORN.COM | REGISTRY NO. 20108

KHA PROJECT
04-0997022
DECEMBER 2023
SCALE AS SHOWN
DESIGNED BY KHA
DRAWN BY JSC
CHECKED BY JMB
LICENSED PROFESSIONAL
RICHARD V. BUSCH, P.E.
FLORIDA LICENSE NUMBER
55568

**EROSION
CONTROL NOTES**

**HEAVY BURRY BOAT RAMP
PREPARED FOR
MARION COUNTY BOARD OF
COUNTY COMMISSIONERS
MARION COUNTY
FLORIDA**

SHEET NUMBER
16

HEAVY BURRY BOAT RAMP – MARION COUNTY MAJOR SITE PLAN

NOTES: 1. DIMENSIONS OF SEDIMENT FILTER DETAILS MAY BE ADJUSTED FOR TYPE "M" CURB INLET TOPS. 2. PRE-MANUFACTURED INLET SOCK MAY BE USED IF APPROVED BY THE ENGINEER. 3. SEE EROSION CONTROL PLAN FOR LOCATION AND APPLICABILITY.

THIS DOCUMENT, TOGETHER WITH THE EROSION CONTROL PLAN, IS TO BE USED ONLY FOR THE SPECIFIC PROJECT AND SITE FOR WHICH IT WAS PREPARED. IT IS THE RESPONSIBILITY OF THE USER TO OBTAIN NECESSARY PERMITS AND TO OBTAIN NECESSARY INFORMATION FROM THE LOCAL AGENCIES AND DESIGN PROFESSIONALS. IT IS THE USER'S RESPONSIBILITY TO OBTAIN NECESSARY PERMITS AND TO OBTAIN NECESSARY INFORMATION FROM THE LOCAL AGENCIES AND DESIGN PROFESSIONALS. IT IS THE USER'S RESPONSIBILITY TO OBTAIN NECESSARY PERMITS AND TO OBTAIN NECESSARY INFORMATION FROM THE LOCAL AGENCIES AND DESIGN PROFESSIONALS.

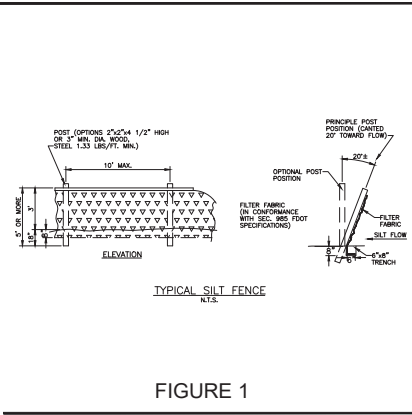


FIGURE 1

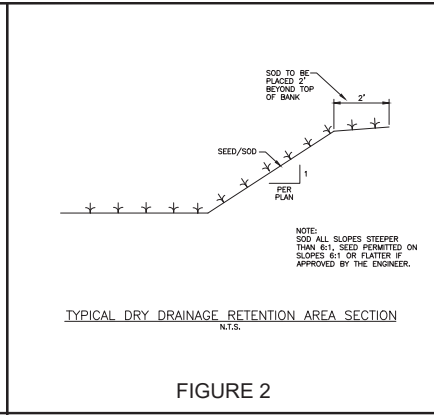


FIGURE 2

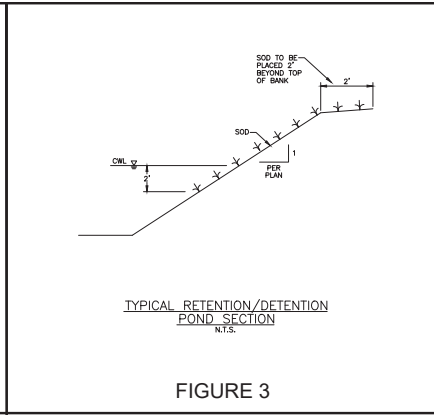


FIGURE 3

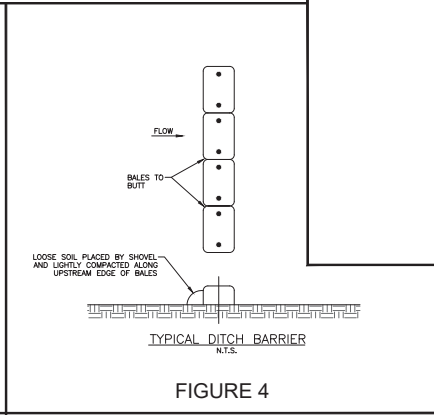


FIGURE 4

NO.	REVISIONS	DATE	BY

Kimley-Horn
© 2023 KIMLEY-HORN AND ASSOCIATES, INC.
1700 E. 77TH AVENUE, SUITE 200, FLORIDA, 32711
WWW.KIMLEY-HORN.COM REBERTY NO. 20108

LICENSED PROFESSIONAL
KHA PROJECT 040997022
DECEMBER 2023
SCALE AS SHOWN
DESIGNED BY KHA
DRAWN BY DSC
CHECKED BY RMB
DATE

EROSION CONTROL DETAILS

HEAVY BURY BOAT RAMP
PREPARED FOR
MARION COUNTY BOARD OF
COUNTY COMMISSIONERS
MARION COUNTY
FLORIDA

SHEET NUMBER
17

HEAVY BURY BOAT RAMP - MARION COUNTY MAJOR SITE PLAN

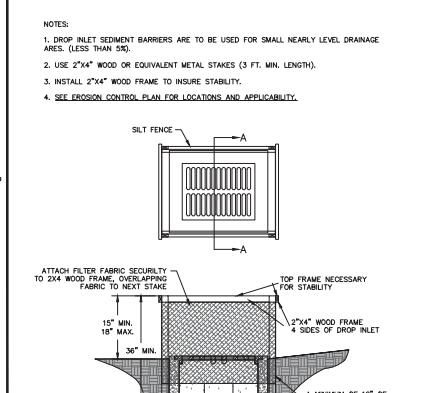


FIGURE 5

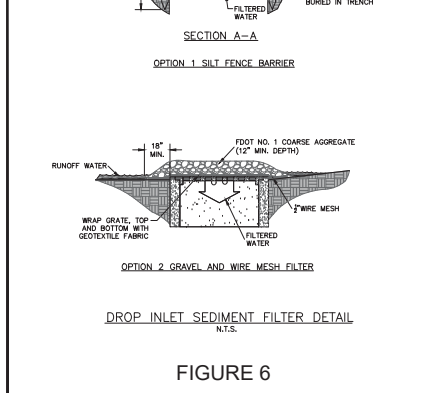


FIGURE 6

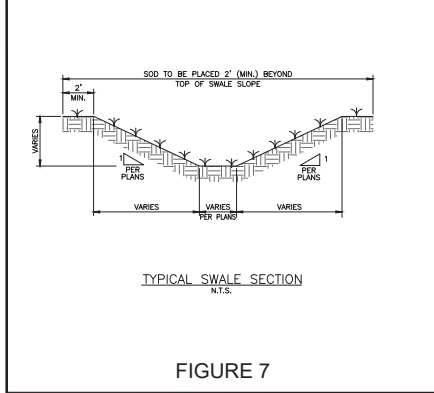


FIGURE 7

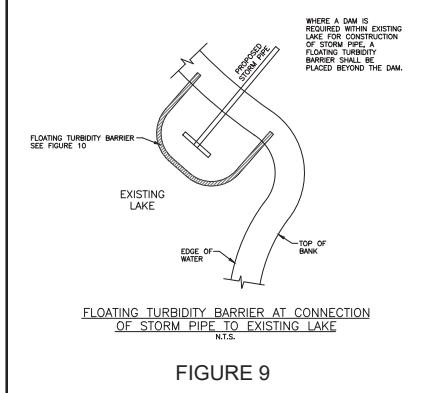


FIGURE 8

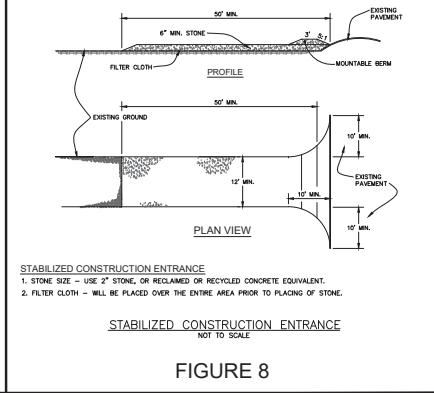


FIGURE 9


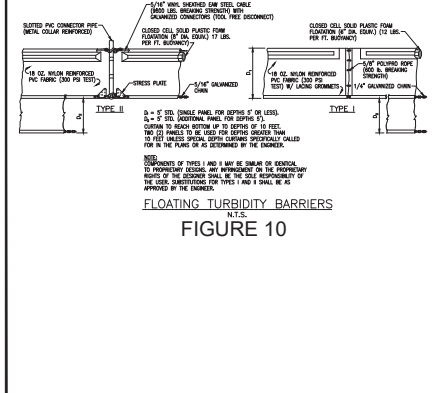


FIGURE 10

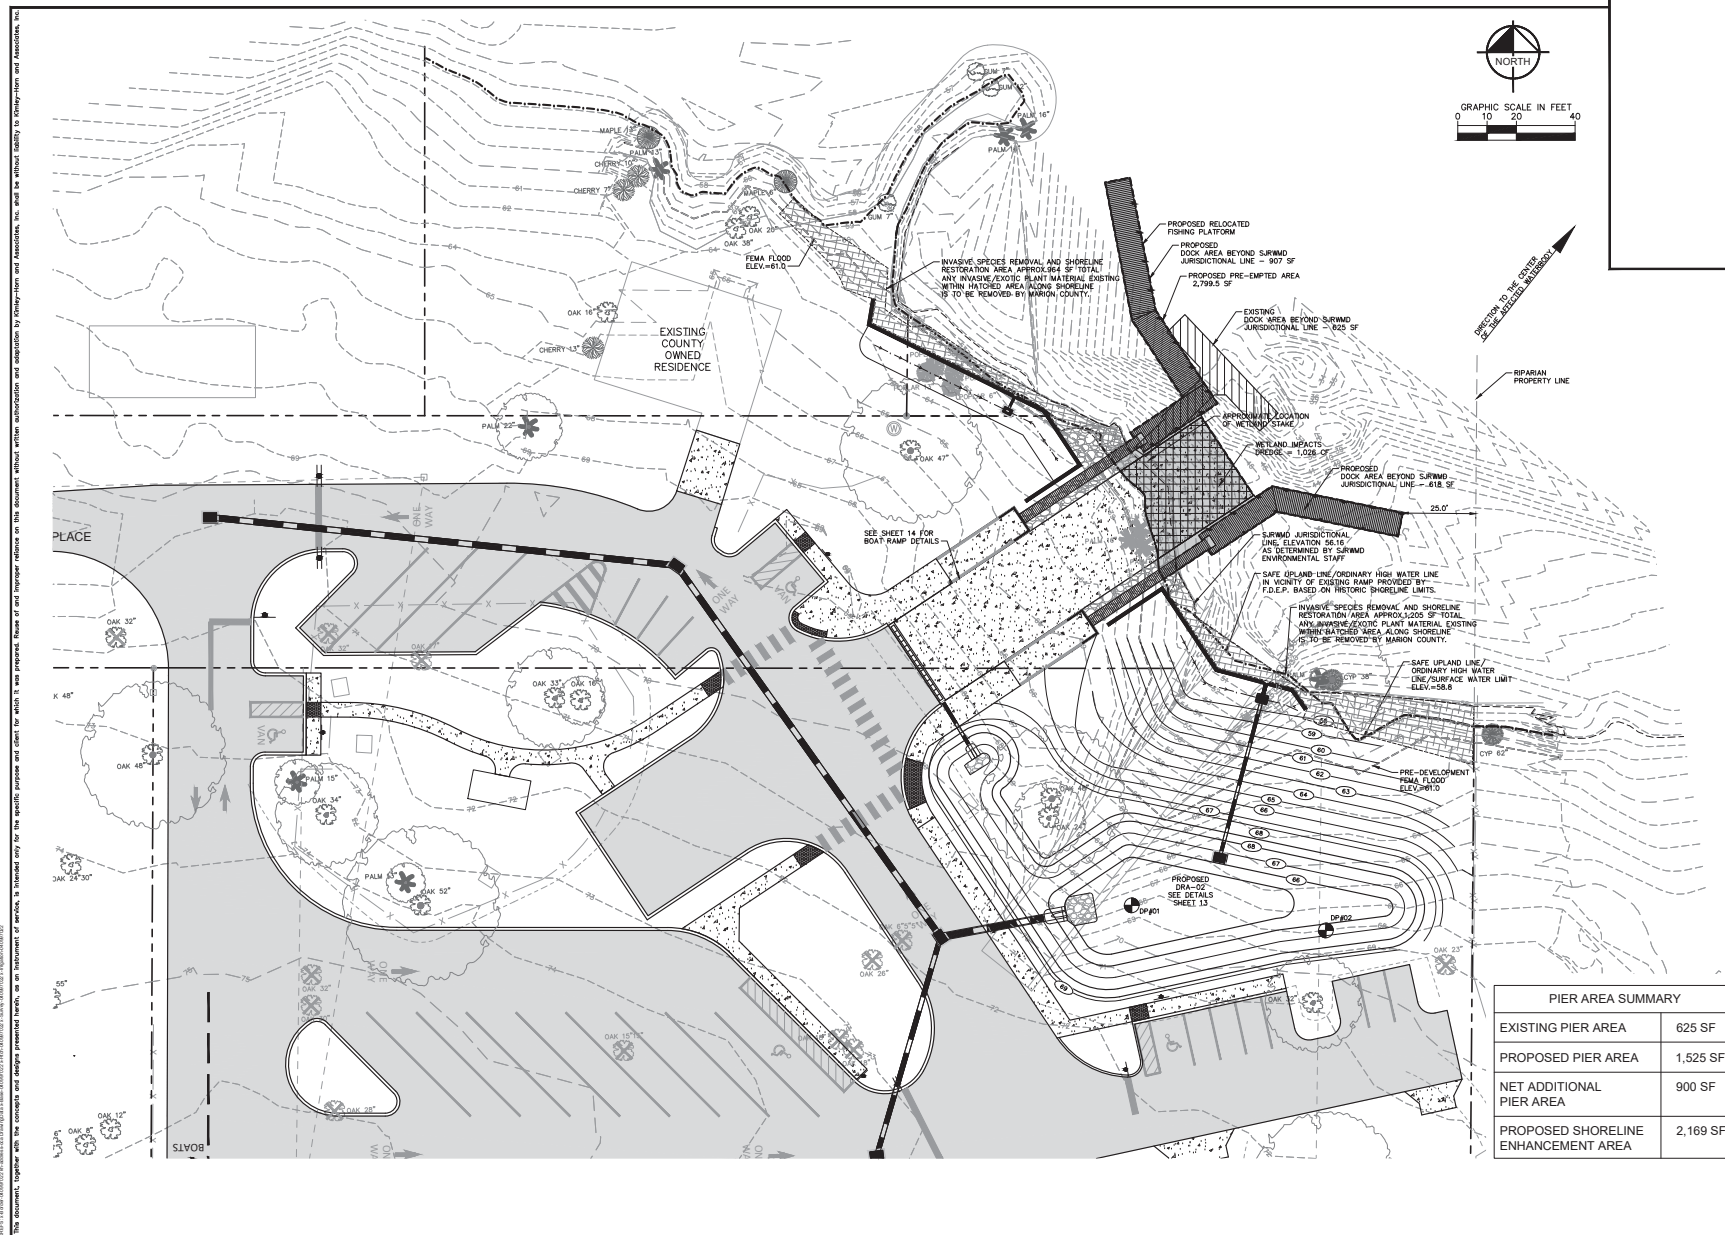

PIER AREA SUMMARY	
EXISTING PIER AREA	625 SF
PROPOSED PIER AREA	1,525 SF
NET ADDITIONAL PIER AREA	900 SF
PROPOSED SHORELINE ENHANCEMENT AREA	2,169 SF

Kimley»Horn
© 2023 KIMLEY-HORN AND ASSOCIATES, INC.
1700 SE 17TH STREET, SUITE 200, OCALA, FLORIDA 34471
PHONE: 352-434-3000
WWW.KIMLEY-HORN.COM REGISTRY NO. 30106

KHA PROJECT 04097022	DATE DECEMBER 2023	LICENSED PROFESSIONAL
SCALE AS SHOWN	RICHARD V. BUSCH, P.E.	FLORIDA LICENSE NUMBER 58568
DESIGNED BY KHA		DATE:
DRAWN BY DSC		
CHECKED BY RVR		

ENVIRONMENTAL
IMPACTS

HEAGY BURRY BOAT RAMP
 PREPARED FOR
 MARION COUNTY BOARD OF
 COUNTY COMMISSIONERS
 MARION COUNTY, FLORIDA

SHEET NUMBER
 18

HYDROGRAPHIC SURVEY OF
HEAGY BURRY BOAT RAMP
FOR
MARION COUNTY PARKS & RECREATION DEPARTMENT
IN SECTION 21, TOWNSHIP 12 SOUTH, RANGE 21 EAST
MARION COUNTY, FLORIDA

DEVELOPMENT REVIEW
COMMITTEE
MARION COUNTY, FLORIDA

APPLICATION #: 13066
APPROVAL DATE: 6/2/2014
EXPIRATION DATE: 6/2/2016

All construction shall conform to the construction standards contained in the Marion County Land Development Code, latest edition. Areas of the right-of-way established during construction shall be delineated and marked. Deeds and maps may be used if approved by the County Engineer or designer.

NOTICE
The approval of these plans is limited to construction under the jurisdiction of Marion County and does not constitute our review the requirements of other agencies for additional permits, as applicable, to state and/or federal laws.

Approval subject to the road abrogation and the easements to the adjacent property owners

GPI Southeast Inc.
1414 S.W. 8th Street, Suite 100
Ocala, Florida 34471 (352) 346-0055
GPI
Engineering • Surveying • Permitting • Environmental Analysis • Construction Services

SHEET INDEX

SHEET 1: COVER SHEET
SHEET 2: HYDROGRAPHIC SURVEY

CONTROL POINT STATE PLANE COORDINATE TABLE			
POINT	NORTHING	EASTING	DESCRIPTION
9	1851514.5057	590136.2986	FOUND MAG NAIL WITH DISK MARKED "QTY LB021"
10	1851502.8437	589834.7706	FOUND MAG NAIL WITH DISK MARKED "QTY LB021"
2101	1851600.5540	590136.3265	SET 5/8" REBAR WITH CAP MARKED "TRAV. PT. LB7560"

LEGEND

- 0.0/-0.0 = DEPTH TO TOP OF MUCK / DEPTH TO BOTTOM OF MUCK (DEPTH IS FROM ORDINARY HIGH WATER)
SURVIMD = MUCK DISTURBED BY VEGETATION CHIPPING ON 4/24/2013
--- = ST. JOHNS RIVER WATER MANAGEMENT DISTRICT
--- = 1.0' INTERVAL CONTOUR LINES
--- = RIGHT-OF-WAY LINE
--- = PARCEL LINES
--- = ORDINARY HIGH WATER LINE (ELEVATION = 58.8 FEET)
--- = APPROXIMATE WATER'S EDGE (ELEVATION = 52.7 FEET)

NOTES:

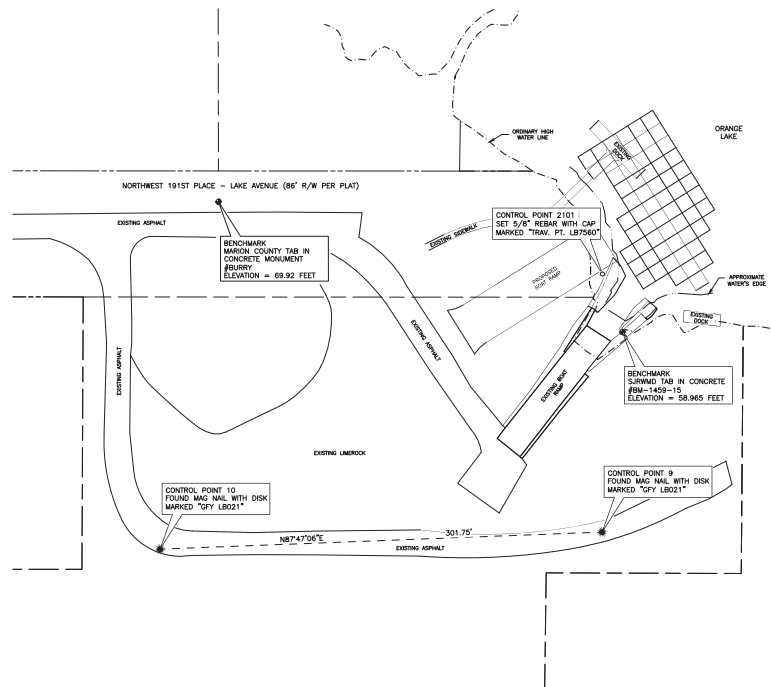
- THE BEARING AND COORDINATES SHOWN HEREON ARE BASED ON THE STATE OF FLORIDA STATE PLANE COORDINATE SYSTEM, WEST FLORIDA ZONE, NORTH AMERICAN DATUM OF 1983, ADJUSTMENT OF 1990, AS TAKEN FROM THE HEAGY-BURRY BOAT RAMP PARK BOUNDARY & TOPOGRAPHIC SURVEY BY GEORGE F. YOUNG, INC., JOB #1000380005, DATED 07/29/2010, WITH THE BEARING BETWEEN CONTROL POINTS 9 AND 10 BEING N87°47'06"E.
- ELEVATIONS SHOWN HEREON ARE BASED ON THE NATIONAL GEODETIC VERTICAL DATUM OF 1929 (NGVD29) DETERMINED BY TIES TO THE FOLLOWING BENCHMARK: BM-1459-15 ELEVATION = 58.965'.
- THIS SURVEY IS OF VISIBLE SURFACE FEATURES ONLY. UNDERGROUND IMPROVEMENTS, INTERIOR IMPROVEMENTS AND/OR ENCROACHMENTS, IF ANY, WERE NOT LOCATED.
- COPIES OF THIS SURVEY ARE NOT VALID WITHOUT THE ORIGINAL SIGNATURE AND RAISED SEAL OF THE FLORIDA LICENSED PROFESSIONAL SURVEYOR AND MAPPER LISTED HEREON.
- TOPOGRAPHIC DATA AND FEATURES ABOVE THE WATER'S EDGE ARE BASED ON PREVIOUS SURVEY REFERENCED IN NOTE 1 ABOVE.
- THE ORDINARY HIGH WATER LINE OF ORANGE LAKE HAS BEEN ESTABLISHED AT AN ELEVATION OF 58.8 FEET, NATIONAL GEODETIC VERTICAL DATUM OF 1929, AS SHOWN ON PREVIOUS SURVEY REFERENCED IN NOTE 1 ABOVE.
- FIELD SURVEY WAS PERFORMED ON THE DATES OF 04/09/2013 THROUGH 04/25/2013.

SURVEYOR'S CERTIFICATE:

I HEREBY CERTIFY THAT WE HAVE MADE A HYDROGRAPHIC SURVEY, THAT IT IS TRUE AND CORRECT TO THE BEST OF OUR KNOWLEDGE AND BELIEF, AND THAT THIS PLAN IS A TRUE AND CORRECT REPRESENTATION THEREOF; AND THAT THIS SURVEY AND PLAN CONFORM WITH THE MINIMUM TECHNICAL STANDARDS AS SET FORTH BY THE FLORIDA BOARD OF PROFESSIONAL SURVEYORS AND MAPPERS IN CHAPTER FJ-17, FLORIDA ADMINISTRATIVE CODE, PURSUANT TO SECTION 472.027, FLORIDA STATUTES.

DATE SIGNED: _____
LAWRENCE E. BLAND
PROFESSIONAL SURVEYOR & MAPPER 4834
STATE OF FLORIDA

DATE OF SURVEY: APRIL 25, 2013




Images

XB/Fs

Project: Job No. Clients:
Boring New A's Land Project/2013/2014 Heagy Burry/Map/NEAR/01.dwg
L:\Users\l\OneDrive\Documents\Projects\Boring New A's Land Project/2013/2014 Heagy Burry/Map/NEAR/01.dwg
L:\Users\l\OneDrive\Documents\Projects\Boring New A's Land Project/2013/2014 Heagy Burry/Map/NEAR/01.dwg

DATE	REVISION	DATE OF SURVEY	FILE #	SECTION	JOB NUMBER	DWG NAME	CADD FILE	A HYDROGRAPHIC SURVEY FOR MARION COUNTY PARKS & RECREATION DEPARTMENT MARION COUNTY, FLORIDA	SHEET NO.
		04-25-2013	PJA/PO-MJ33M/48	SECTION 21 - T.12S-R.21E	POC-201300.04	HEAGY BURRY.DWG	HEAGY BURRY.CRD		1 OF 2

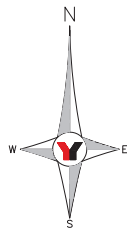

1. The measured bearings herein are based on the assumed bearing of S89°44'05"E, between found monumentation, along the South line of Section 21, Township 12 South, Range 21 East, Marion County, Florida.
2. Underground utilities, structures and/or foundations, if any, were not located or shown.
3. Recorded easements and/or adjacent deeds not furnished to the surveyor are not shown.
4. Jurisdictional wetlands, if any, were not located and are not shown.
5. The bearing along the East right of way line of NN 51st City – Beach Street (40' R/W) has been established as a best fit line to the existing monumentation found along said line.
6. The bearing along the South right of way line of NN 191st Place – Lake Avenue (66' R/W) has been established as a best fit line to the existing monumentation found along said line. Said right of way line was found to 10.71' North of the distance shown on the Plot of Lockbie.
7. There is apparent 50.10' overlap in the existing monumentation when compared to the deed description for Tax Parcel #002786-001-000 and the Marion County Property Appraiser's legal description for Tax Parcel #002786-001-000. Said overlap is shown on the Plot of Lockbie.

Approval subject to the road abrogation and the easements to the adjacent property owners

STATE PLANE COORDINATES FOR BOUNDARY CORNERS (SEE MAP TO LEFT)			
CORNER NUMBER	NORTHING	EASTING	CORNER FOUND/SET
5	1851486.719	5900098.0981	CMF (NO ID.)
15	1851486.277	590231.1890	CMF (NO ID.)
5	1851488.378	590190.5041	CMF (HARCON ENCL.)
15	1851489.214	5906909.0595	RFC 1/2" (PSM 2232)
1034	1851302.233	5900095.8552	CMF (HARCON ENCL.)
1240	1851255.600	5906906.4478	CMF (BROKEN - NO ID.)
1231	1850893.740	5906905.0507	RFC 5/8" (PSM 1918)
1244	1851251.995	590135.2759	CMF (PSM 1918)
1000	1850892.280	590135.2524	RCS
1404	1851674.756	590135.4913	RFC 5/8" (PLS 1918)
RCS	1851760.745	590039.0933	RCS

RCS - INDICATES 1/2" STEEL ROD & CAP NIPSET (GTY LB021)
 CMF - INDICATES 4" x 4" CONCRETE MONUMENT FOUND (ID. AS NOTED)
 RFC - INDICATES STEEL ROD & CAP FOUND - (SIZE & ID. AS NOTED)
 NOTE: THESE COORDINATES HAVE BEEN DERIVED USING MARION COUNTY
 HORIZONTAL CONTROL STATION DATA

THE EAST 50 FEET OF MILL LOT OF ORANGE LAKE, ACCORDING TO THE PLAT THEREOF AS RECORDED IN PLAT BOOK A, PAGE(S) 42A, OF THE PUBLIC RECORDS OF MARION COUNTY, FLORIDA.

COMMENCE AT THE NORTHEAST CORNER OF BLOCK 21, OF LOCKBIE, (ORANGE LAKE), AS PER PLAT RECORDED PLAT BOOK E, PAGE 36, OF THE PUBLIC RECORDS OF MARION COUNTY, FLORIDA, THENCE RUN 40 FEET EAST TO THE EAST BOUNDARY OF BEACH STREET; AND THENCE RUN SOUTH 177 FEET TO THE POINT OF BEGINNING, CONTINUE SOUTH ALONG THE EAST BEACH STREET TO A POINT ON THE SOUTH BOUNDARY OF SECTION 21, TOWNSHIP 12 SOUTH, RANGE 21 EAST; THENCE RUN EAST ALONG THE SOUTH BOUNDARY OF SAID SECTION 21, A DISTANCE OF 538.03 FEET, THENCE RUN NORTH 382 FEET, MORE OR LESS, TO THE NORTH BOUNDARY OF SAID SECTION 21, TOWNSHIP 12 SOUTH, RANGE 21 EAST, THENCE RUN NORTH 184 FEET, THENCE WEST 323.43 FEET TO THE POINT OF BEGINNING, CONTINUE WEST ALONG THE NORTH BOUNDARY OF SAID SECTION 21, TOWNSHIP 12 SOUTH, RANGE 21 EAST, TO THE POINT OF BEGINNING, BEING THE CORNER OF THE TRACT OF LAND DESCRIBED IN DEED BOOK 324, PAGE 135, OF THE PUBLIC RECORDS OF MARION COUNTY, FLORIDA.

(TAX PARCEL #02786-005-001) O.R. 5246, PG. 943

THAT PORTION OF THE FOLLOWING DESCRIBED PARCEL LYING TO THE NORTH OF THE EXISTING PUBLIC RIGHT OF WAY

COMMENCE AT THE NORTHEAST CORNER OF BLOCK 21, TOWN OF LOCKBEE, (ORANGE LAKE), AS PER PLAT RECORDED IN PLAT BOOK E, PAGE 36, OF THE PUBLIC RECORDS OF MARION COUNTY, FLORIDA; THENCE RUN 40 FEET EAST TO THE WEST BOUNDARY OF BEACH ROAD, THENCE RUN 177 FEET TO THE POINT OF BEGINNING, CONTINUE WITH ALONG THE EAST BOUNDARY OF BEACH ROAD, THENCE RUN 100 FEET SOUTH, THENCE RUN 100 FEET WEST TO THE WEST BOUNDARY OF SECTION 21, TOWNSHIP 30 SOUTH, RANGE 21 EAST; THENCE EAST ALONG THE SOUTH BOUNDARY OF SAID SECTION 21, A DISTANCE OF 132.03 FEET; THENCE RUN NORTH 382 FEET, MORE OR LESS, TO THE NORTH BOUNDARY OF A 50 FOOT COUNTY ROAD AS RECORDED IN DEED BOOK 3224, PAGE 135; THENCE WEST ALONG THE NORTH BOUNDARY OF SAID ROAD 215 FEET; THENCE NORTH 184.71 FEET; THENCE WEST 323.43 FEET TO THE POINT OF BEGINNING.

(TAX PARCEL #02791-005-000) 0.8 3077 PG. 576

THE FOLLOWING DESCRIBED LAND FOUND IN SECTION 21, TOWNSHIP 12 SOUTH, RANGE 21 EAST IN MARION COUNTY, FLORIDA AS DESCRIBED LOCKBIE SUBDIVISION FOUND IN THE PUBLIC RECORDS OF MARION COUNTY PLAT BOOK "E" PAGE 36 AND MORE PARTICULARLY DESCRIBED AS FOLLOWS:

COMMENCING AT THE NORTHEAST CORNER OF BLOCK #21 LOOKSBE SUBDIVISION AS RECORDED IN THE PUBLIC RECORDS OF MARION COUNTY PLAT BOOK #7, PAGE 436, THENCE EAST ALONG THE SOUTH RIGHT OF WAY OF LAKE AVE., (A.K.A. N.W. 191ST PLACE HAVING A TOTAL RIGHT OF WAY WIDTH OF 86.00 FEET) TO THE POINT OF BEGINNING A DISTANCE OF 21.00 FEET; THENCE S00°44'13"W A DISTANCE OF 185.86 FEET; THENCE S89°46'40"E A DISTANCE OF 101.71 FEET; THENCE S00°00'00"W A DISTANCE OF 10.29 FEET; THENCE S00°00'00"W A DISTANCE OF 161.23 FEET; THENCE S00°21'15"W A DISTANCE OF 184.71 FEET; THENCE WEST A DISTANCE OF 102.00 FEET; THENCE N00°21'15"E TO SAID SOUTH RIGHT OF WAY OF LAKE AVE. A DISTANCE OF 102.00 FEET; THENCE N00°21'15"E TO THE SOUTH RIGHT OF WAY OF N.W. 191ST PLACE A DISTANCE OF 177.00 FEET; THENCE WEST ALONG SAID RIGHT OF WAY TO THE POINT OF BEGINNING A

*****SURVEYOR'S NOTE- THIS LEGAL DESCRIPTION D

(TAX PARCEL #02786-003-001) O.R. 5174, PG. 1335
THE FOLLOWING DESCRIBED LAND FOUND IN SECTION 21 TOWNSHIP 12 SOUTH, RANGE 21 EAST IN MARION COUNTY, FLORIDA AS DESCRIBED LOOKBEE SUBDIVISION FOUND IN THE PUBLIC RECORDS OF MARION COUNTY PLAT BOOK "E", PAGE
#36 AND MORE PARTICULARLY DESCRIBED AS FOLLOWS:

COMMENCING AT THE NORTHEAST CORNER OF BLOCK #21 COOKSIE SUBDIVISION AS RECORDED IN THE PUBLIC RECORDS OF MARION COUNTY PLAT BOOK "T", PAGE 836; THENCE EAST ALONG THE SOUTH RIGHT OF WAY TO LAKE WAKA, NEAR 191ST PLACE HAVING A TOTAL RIGHT OF WAY WIDTH OF 86.00 FEET; A DISTANCE OF 210.04 FEET; THENCE S00°44'13"W A DISTANCE OF 185.86 FEET; THENCE S00°46'47"E A DISTANCE OF 101.79 FEET; THENCE S00°40'56"W, TO THE WEST LINE OF ORANGE LAKE; THENCE S00°40'56"W A DISTANCE OF 13.81 FEET; THENCE CONTINUING ALONG SAID NORTH RIGHT OF WAY LINE S00°40'47"E A DISTANCE OF 53.81 FEET; THENCE N02°07'11"E A DISTANCE OF 18.06 FEET; THENCE S00°55'05"E A DISTANCE OF 133.18 FEET; THENCE N02°15'E TO THE MEAN HIGH WATER LINE OF ORANGE LAKE A DISTANCE OF 171.34 FEET; THENCE N02°07'11"E ALONG SAID HIGH WATERLINE A DISTANCE OF 53.61 FEET; THENCE S00°50'14"E A DISTANCE OF 167.15 FEET; THENCE N02°15'E A DISTANCE OF 133.2

I hereby certify to Marion County Board of County Commissioners that the sketch herein is an accurate representation of the land described herein, is in compliance with the Minimum Technical Standards in Chapter 35 of the Florida Administrative Code as set forth by the Florida Board of Professional Surveyors and Mappers pursuant to Section 472.027 Florida Statutes, as surveyed under my direct supervision and is true and correct to the best of my knowledge and belief.

NOT VALID WITHOUT THE SIGNATURE AND THE ORIGINAL RAISED SEAL
OF A FLORIDA LICENSED SURVEYOR AND MAPPER.

Michael L. Herbert PSM4995

DATE

HEAGY-BURRY BOAT RAMP PARK BOUNDARY & TOPOGRAPHIC SURVEY		JOB NO. 10003800GS
SECTION 21, TOWNSHIP 12 S., RANGE 21 E. MARION COUNTY, FLORIDA		SHEET NO. 1 OF 4

THIS IS A 4 SHEET DRAWING AND IS NOT
COMPLETE OR VALID WITHOUT ALL 4 SHEETS.

REVISED	NO.	BY	DATE	DESCRIPTION	REVISED	NO.	BY	DATE	DESCRIPTION	INITIALS	DATE	
	1					6						
	2					7					SECRET	07/29/10
	3					8					GRABIN	07/30/10
	4					9					CHEKED	
	5					10					FIELD BOOK	SEE FILE FOLDER
												FIELD DATE




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tech: harbert File: 10003900GS.dwg Plot Date: Apr 23, 2014 8:21am



POINT	ELEVATION TABLE (FEET)			HARD OR MUD BOTTOM BELOW BOTTOM OF MUCK
	TOP OF MUCK ELEVATION	BOTTOM OF MUCK ELEVATION	DEPTH OF MUCK	
2002	45.6	39.3	10.3	MUD
2003	43.3	34.4	8.9	MUD
2004	46.1	35.7	10.4	MUD
2005	48.8	42.0	6.8	MUD
2006	48.3	40.3	8.0	HARD
2008	45.6	33.1	12.5	MUD
2009	46.7	36.2	10.5	MUD
2010	46.4	34.4	12.0	MUD
2011	46.4	36.6	9.8	MUD
2012	49.9	49.9	0.0	HARD
2014	49.5	36.1	13.4	MUD
2015	48.6	35.6	17.0	MUD
2016	48.0	37.1	10.9	MUD
2018	47.0	45.7	1.3	MUD
2020	48.4	35.1	13.3	MUD
2021	49.0	33.5	15.5	MUD
2022	47.6	37.1	10.5	MUD
2024	47.6	40.6	7.0	MUD
2026	49.6	37.5	12.1	MUD
2027	48.9	38.3	10.6	MUD
2028	48.6	37.4	11.2	MUD
2029	48.4	36.5	11.9	MUD
2030	46.5	45.5	1.0	MUD
2031	47.6	47.0	0.6	MUD
2033	49.3	40.8	8.5	MUD
2034	49.5	35.9	13.5	MUD
2035	48.7	37.3	11.4	MUD
2037	48.6	38.8	9.8	MUD
2038	48.6	45.4	3.2	MUD
2039	50.3	49.8	0.5	HARD
2041	49.4	44.0	5.4	MUD
2042	49.4	43.3	6.1	MUD
2043	49.1	44.4	4.7	MUD
2044	49.1	46.8	2.3	MUD
2045	48.8	46.4	2.4	HARD*
2046	49.5	47.9	1.6	HARD*
2047	50.4	50.4	0.0	HARD*
2049	49.5	46.2	3.3	MUD
2050	49.4	48.7	0.7	MUD
2051	48.9	44.0	4.9	MUD
2052	48.5	44.4	4.1	MUD
2053	48.7	46.6	2.1	MUD
2054	49.1	46.9	2.2	HARD*
2055	49.7	47.8	1.9	HARD*
2056	51.4	51.4	0.0	HARD*
2057	49.4	47.4	2.0	MUD
2058	49.4	46.1	3.3	MUD
2059	49.2	47.0	2.2	HARD*
2060	48.9	46.9	2.0	HARD*
2061	48.7	46.6	2.1	HARD*
2062	48.9	46.9	1.9	HARD*
2063	49.5	47.2	2.3	HARD*
2064	49.5	48.7	0.8	MUD
2065	48.7	46.7	2.0	HARD*
2066	49.0	47.6	1.4	HARD*
2067	48.9	47.4	1.5	HARD*
2068	49.1	47.2	1.9	HARD*
2069	49.2	47.2	2.0	HARD*
2070	49.8	47.0	2.9	HARD*
2071	49.1	46.4	2.7	CONCRETE*
2072	49.3	46.6	2.7	HARD*
2073	49.5	48.1	1.4	HARD*
2074	49.4	46.6	2.8	HARD*
2075	49.1	47.0	4.1	HARD*
2076	49.5	47.0	2.5	HARD*
2077	49.9	47.4	2.5	CONCRETE*
2078	49.8	48.4	1.4	HARD*
2079	49.4	47.4	2.0	HARD*
2080	49.9	49.1	0.8	HARD*
2081	51.2	51.2	0.0	HARD*
2083	51.0	53.0	0.0	HARD*
2084	51.0	51.5	0.5	HARD*
2089	49.6	50.0	11.7	MUD
2091	48.2	48.2	0.0	MUD
2092	48.6	36.6	12.0	MUD
2093	47.4	37.7	9.7	MUD
2094	48.4	33.2	17.2	MUD
2095	47.4	38.6	8.8	MUD

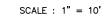